
Shilling Park

14469 Rev. Maurice Cotton Drive, Lathrop, CA

City of Lathrop Public Works Department

Landscape Improvement Plans

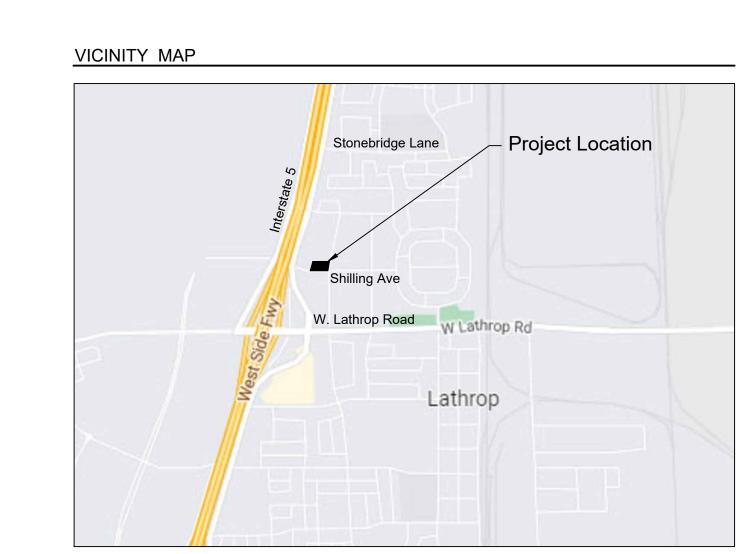

| , | ABBREVIAT | IONS |
|---------------------|-----------|------------------------------------|
| | AB | AGGREGATE BASE OR ANCHOR BOLT |
| AC | | ASPHALTIC CONCRETE |
| | ACP | ASPHALTIC CONCRETE PAVING/PAVEMENT |
| | | ADJACENT |
| | ALT | ALTERNATE |
| | AP | ANGLE POINT |
| | | APPROXIMATE |
| | BLDG | BUILDING |
| | СВ | CATCH BASIN |
| | CF | CUBIC FOOT |
| | C/L , CL | CENTERLINE |
| | CLR | CLEAR |
| | CONC | CONCRETE |
| | CONST | CONSTRUCTION |
| | CONT | CONTINUOUS, CONTINUE |
| | CTR | CENTER |
| | DI | DRAIN INLET |
| | DIA | DIAMETER |
| | DWG | DRAWING |
| | EA | EACH |
| | EJ, EX JT | EXPANSION JOINT |
| | ELECT | ELECTRICAL |
| | EP | EDGE OF PAVEMENT |
| | EQ | EQUAL |
| | EX | EXISTING |
| | EXIST | EXISTING |
| | (E) | EXISTING |
| | FD | FRENCH DRAIN |
| | FES | FLARED END SECTION |
| | FF | FINISHED FLOOR |
| | FFE | FINISHED FLOOR ELEVATION |
| | FG | FINISHED GRADE |
| FL FLOW LINE | | FLOW LINE |
| FS FINISHED SURFACE | | FINISHED SURFACE |
| | FTG | FOOTING |
| | FUT | FUTURE |
| | GB | GRADE BREAK |
| | GPH | GALLONS PER HOUR |
| | GPM | GALLONS PER MINUTE |
| | GR | GRATE |

INVERT ELEVATION INTERSECTION **INVERT** LENGTH LEFT HAND LOW POINT LEFT MATERIAL MAT'L MAX MAXIMUM MED MEDIUM MANUFACTURE(R) MINIMUM MISC MISCELLANEOUS MAINLINE NEW NOT APPLICABLE NOT IN CONTRACT NUMBER NOT TO SCALE ОС ON CENTER OUTSIDE DIAMETER OVERHEAD OPP OPPOSITE OPTIONAL PLANTER AREA POINT OF CURVE PERF PERFORATED PERP PERPENDICULAR PROPERTY LINE POB POINT OF BEGINNING POC POINT OF CONNECTION POINT OF REVERSE CURVE PROP PROPOSED POINT, POINT OF TANGENCY QUARTER POINT ON ARC HALF POINT ON ARC THREE-QUARTER POINT ON ARC POUNDS PER SQUARE INCH PUBLIC UTLITIES EASEMENT

POLYVINYL CHLORIDE

REINFORCING BAR

RADIUS

REBAR

| REC | RECOMMENDED OR RECOMMENDATION |
|------------|-------------------------------|
| REF | REFERENCE |
| REM | REMOVE |
| REQ, REC'D | REQUIRED |
| REV | REVISION(S), REVISED |
| RH | RIGHT HAND |
| ROW | RIGHTOFWAY |
| RT | RIGHT |
| S | SLOPE |
| SCH | SCHEDULE |
| SD | STORM DRAIN |
| SE | SOUTHEAST |
| SG | SUB-GRADE |
| SHT | SHEET |
| SIM | SIMILAR |
| SL | SLOPE |
| SPEC | SPECIFICATION(S) |
| SQ | SQUARE |
| SF | SQUARE FEET |
| SS | SANITARY SEWER |
| STD | STANDARD |
| SURF | SURFACE |
| SW | SOUTHWEST |
| SWCL | SIDEWALK CENTERLINE |
| SYS | SYSTEM |
| TBC | TOP BACK OF CURB |
| TC | TOP OF CURB |
| TS | TOP OF STEP |
| TS | TUBE STEEL |
| TW | TOP OF WALL |
| TYP | TYPICAL |
| UON | UNLESS OTHERWISE NOTED |
| VAR | VARIES |
| W | WATER |
| W/ | WITH |
| W/O | WITHOUT |
| | |
| | |
| | |
| 1 | |

GENERAL NOTES

- The landscape drawings are part of and intended to be complementary to the drawings of the civil engineer and of other disciplines. Prior to start of Work, review all drawings, documents, and reports associated with this project and coordinate the work of the landscape drawings with the work of the other disciplines as necessary to ensure a fully complete and coordinated installation.
- Prior to start of work, thoroughly review all Contract Documents and become thoroughly familiar with the requirements and the intent of these documents including all contract requirements.
- Prior to start of any work, obtain all necessary permits from the City, State and all other agencies having jurisdiction over the work.
- Prior to start of construction and as necessary throughout the progress of the Work, contact the Underground Service Alert with minimum 48 hours notice, and have all underground utilities and facilities marked in the field and verify by pot holing, the types, locations, sizes and/or depth of existing utilities within the work area. In the event existing utilities are discovered to be in conflict with the work required of the Contract Documents, immediately notify the Owner and the affected utility company in the most expeditious means available and later confirm in writing. Determine exact locations of all utilities and facilities and implement appropriate and effective measures to protect them.
- Protect all existing monuments and other survey markers on the project site. Record the location of all monuments and other survey markers prior to the start of work. All such monuments or markers disturbed or destroyed during construction shall be replaced by a licensed surveyor at the Contractor's expense.
- If during the course of any excavation evidence of archaeological resources including but not limited to artifacts and human remains are encountered, immediately stop all work and activities that may damage or destroy such resources and notify the Owner. Do not re-start affected work and activities until the Owner has provided direction to do so.
- All work shall conform to applicable governing codes. At commencement of construction Owner and Contractor shall be responsible to consult with applicable agencies to determine if applicable codes, regulations, or governing ordinances have changed and determine if changes to the plans are required to comply with requirements. Changes to plans for updating due to these changes shall be solely

the responsibility of the Owner.

- All traffic controls shall be in conformance with Caltrans Manual of Traffic Controls and these Contract Documents.
- Verify all work described in the Drawings for dimension, grade, extent, and compatibility with existing site conditions. Any discrepancies and unexpected conditions that affect or change the work described in the contract documents shall be brought to the Landscape Architect's attention immediately. Do not proceed with the work in the area of discrepancies until all such discrepancies are resolved. Proceeding with affected work prior to acceptable resolution will be at Contractor's own risk and may require the Contractor to remove and replace work and execute extra work at no additional cost to the Owner.
- Omissions from the Drawings or Specifications or the misdescription of any work, which is manifestly necessary to carry out the intent of the Drawings and Specifications, or which is customarily performed, shall not relieve the Contractor from performing such omitted or described details of the work. Contractor shall perform such work as if fully and completely set forth and described in the drawings and specifications.
- Written dimensions shall take precedence over drawing scale or proportion. Larger scale drawings shall take precedence over small scale drawings.
- Removal and replacement limits of any existing feature shown on the Drawings are for general reference only. Actual limits shall be as required by the new work and shall be verified in the field with Owner.
- 13. RECORD DRAWINGS: Maintain one set of Contract Documents on site for use in documenting current progress of work and all changes. Document progress and changes with red, indelible ink. Make documents available to Landscape Architect for review at all site visits and as requested. Draft all changes in CAD files copy and note changes to specifications on copies of the original specifications using indelible black or red ink as directed. Unless otherwise specified, these shall serve as the Record
- Documents that must be submitted prior to final payment. 14. The Owner may have other work within this project area being executed under separate contracts by other contractors ("others") concurrently with the execution of work covered by these documents. Contractor shall coordinate work of this contract with work of others as necessary to ensure the proper interface of this work with work of others and by such means, methods, and timing that the work of others is not impeded.

SHEET INDEX

- L0.1 COVER SHEET
- L0.2 LANDSCAPE NOTES L1.1 - SITE CONSTRUCTION PLAN
- L1.2 LANDSCAPE DRAINAGE AND GRADING PLAN
- L2.1 L2.15 SITE CONSTRUCTION DETAILS
- L3.1 IRRIGATION PLAN
- L4.1 PLANTING PLAN
- L5.1 L5.3 IRRIGATION DETAILS
- L6.1 PLANTING DETAILS
- L7.1 WELO NOTES AND CALCULATIONS

PROJECT INFORMATION

Project Name: Shilling Park City of Lathrop Project Applicant: Project Address: 14469 Rev. Maurice Cotton Drive

Total Landscape Area: Project Type:

Private Commercial Municipal Potable Water Supply: Owner Information:

City of Lathrop - Public Works Department 390 Towne Centre Drive Lathrop, CA 95330 (209) 941-7200 Contact: Ken Reed

Lathrop, CA

34,861 sf





Prepared for City of Lathrop 390 Towne Centre Drive Lathrop, CA 95330

(209) 941-7200

HILLIN


Revision: 1 Addendum 1 5/25/23


04 May 2023 Date: RSH Drawn: RSH Checked: 22-021 Project No.:

Cover Sheet

HIGH POINT

INSIDE DIAMETER

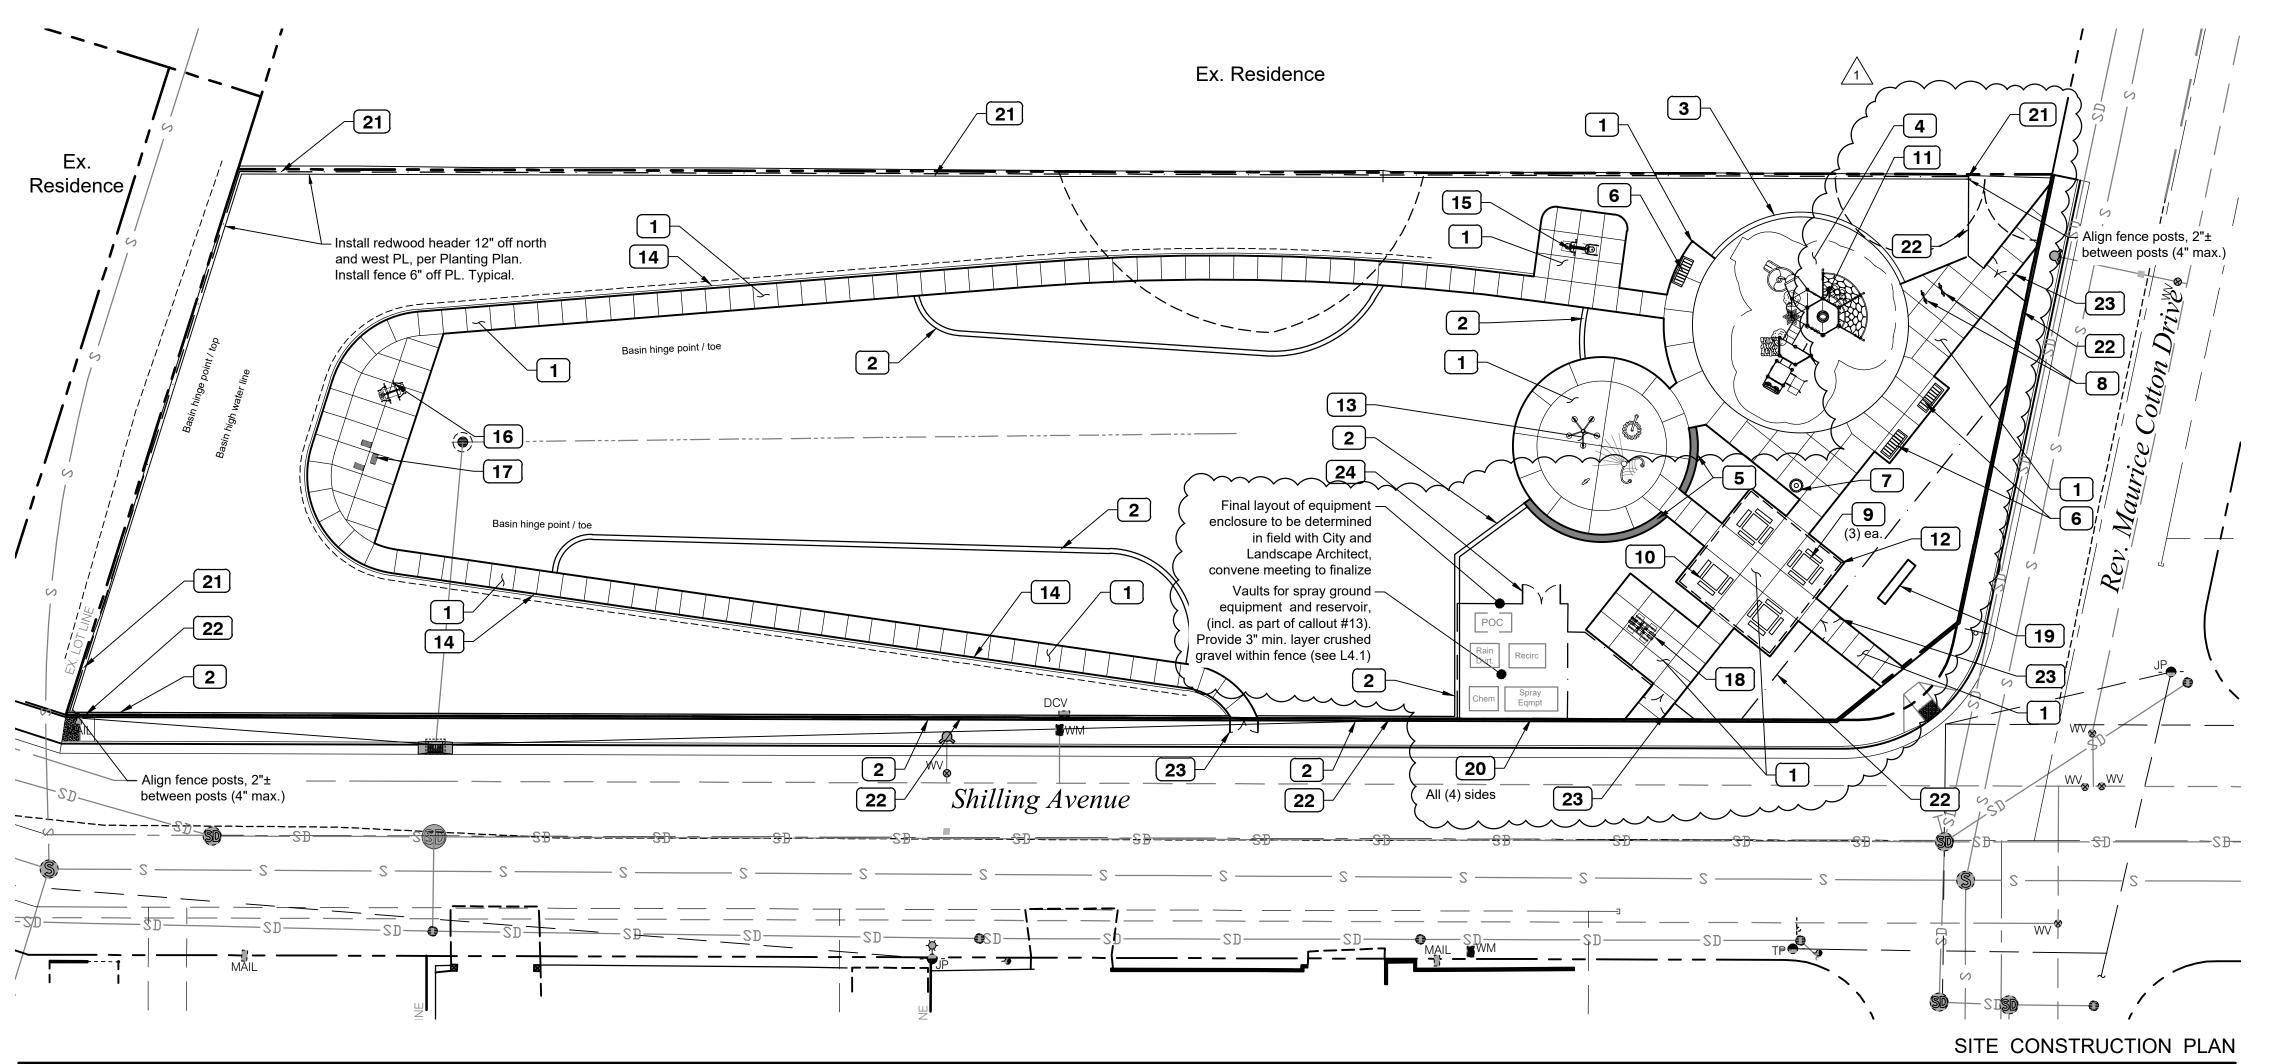

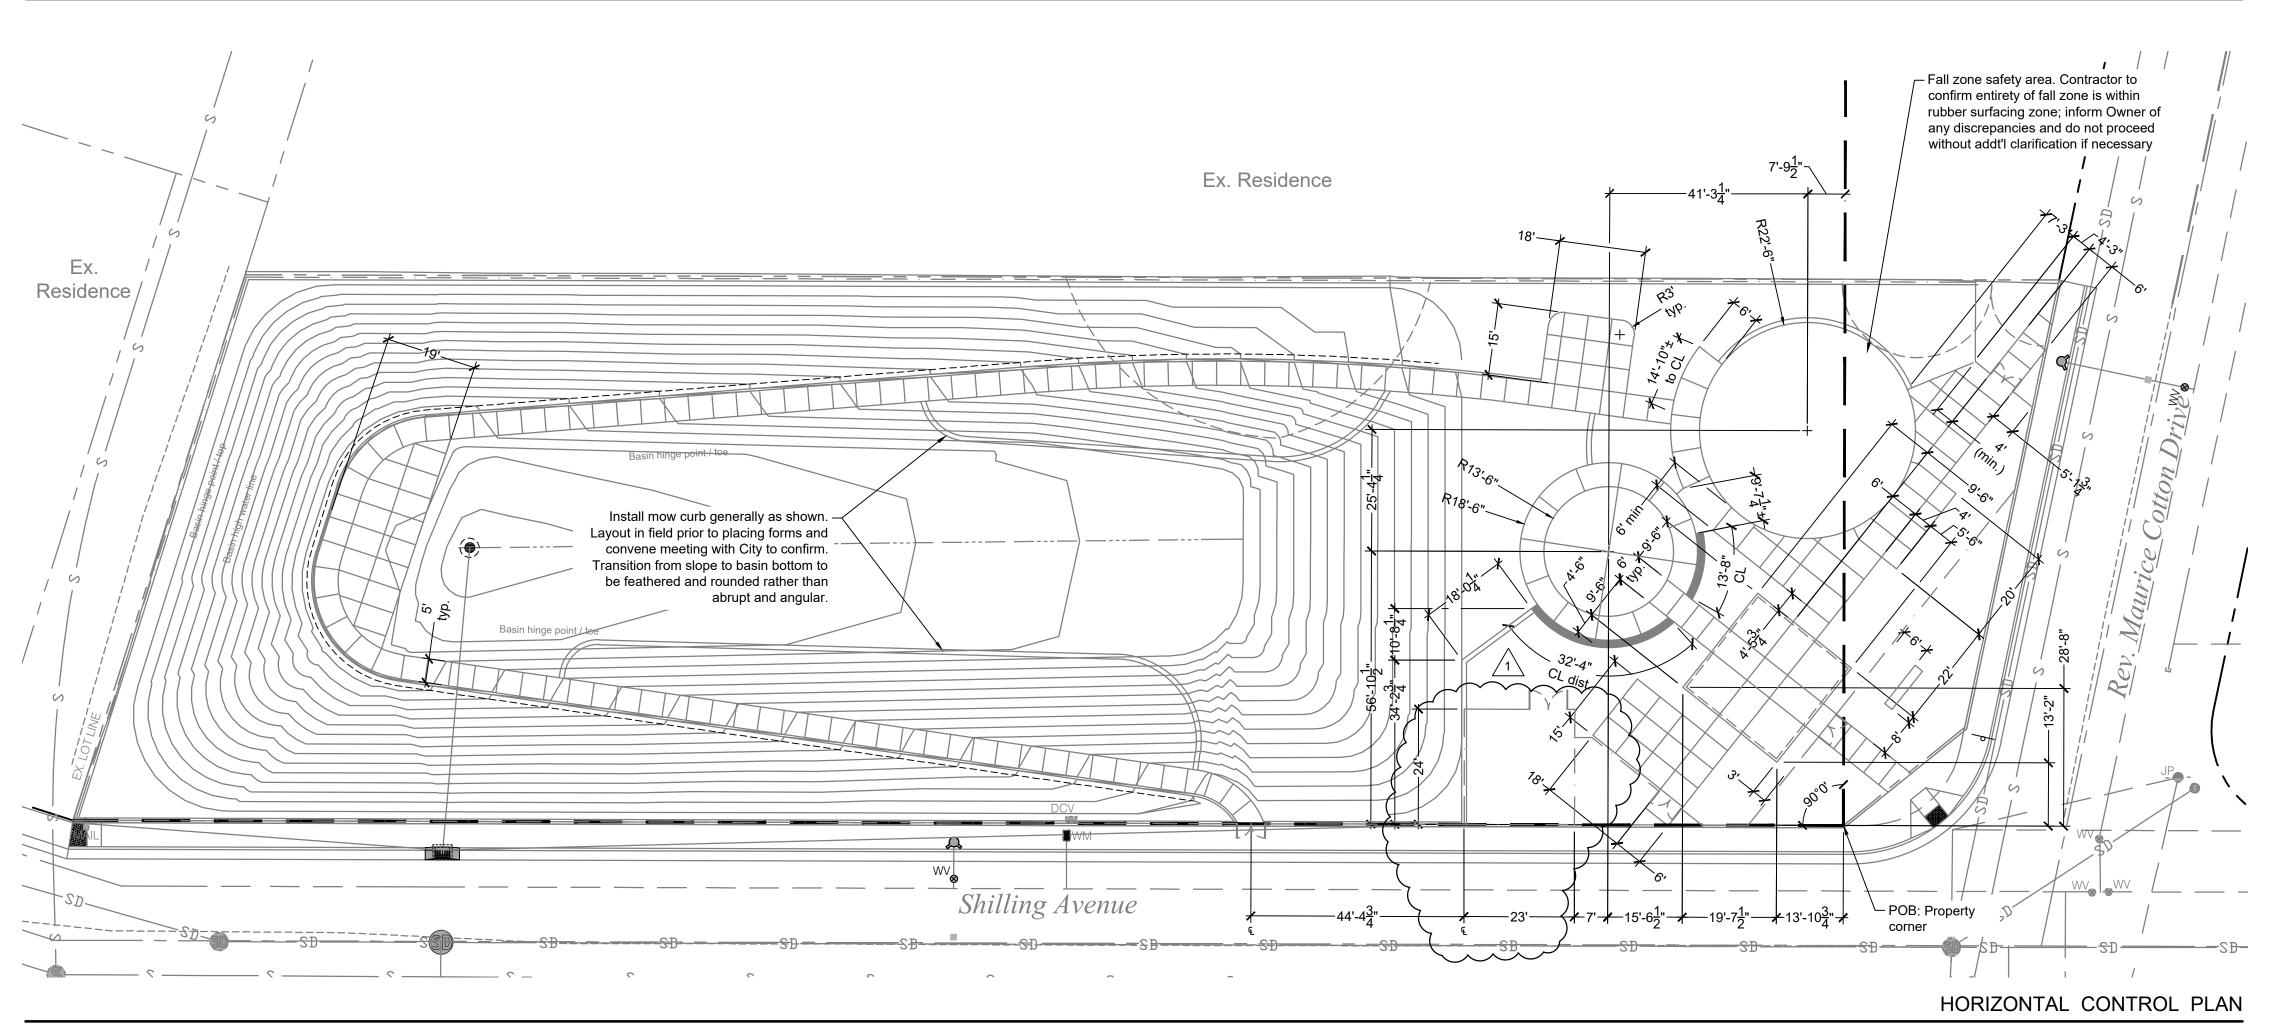

| SYMBOL | DESCRIPTION | DETAIL |
|-------------|---|--------|
| 1 | Install pedestrian grade concrete paving. Provide control joints at 6`+/-o.c., or as shown on plans, and provide expansion joints max 20` o.c. Provide medium broom finish with 1.5% cross slope (2% max), and less than 5% longitudinal slope U.O.N. Submit mix design for approval. | 1/L2.1 |
| 2 | Install concrete mow curb. Provide score joints 10` o.c., align with adjacent paving when occurs. Provide medium broom finish. | 3/L2.1 |
| 3 | Install concrete edge curb at play area. | 4/L2.1 |
| 4 | Install poured-in-place rubberized surfacing. Allow for three (3) colors. Material: SpectraPour by Spectra Turf, www.spectraturf.com. See detail for colors, color layout, and blend ratio. Submit product data for approval. | 4/L2.1 |
| 5 | Install C.I.P seat wall at spray ground. Submit shop drawings for approval. | 5/L2.1 |
| 6 | Install bench, surface mount per manufacturer`s specifications. Model 58-80 manufactured by Dumor, www.dumor.com. Powder coated finish. Color: Bronze. Submit product data for approval. | 6/L2.1 |
| 7 | Install split-stream trash/recycle receptacle, surface mount per manufacturer's specifications. Model 437-40SH manufactured by Dumor, www.dumor.com. Powder coated finish. Color: Bronze. Submit product data for approval. | 7/L2.1 |
| 8 | Install bike rack, surface mount per manufacturer's specifications. Model 292 manufactured by Dumor, www.dumor.com. Powder coated finish. Color: Bronze. Submit product data for approval. | 1/L2.2 |
| 9 | Install picnic table, surface mount per manufacturer's specifications. Model 448-44 manufactured by Dumor, www.dumor.com. Powder coated finish. Color: Bronze. Submit product data for approval. | 3/L2.2 |
| 10 | Install ADA-accessible picnic table, surface mount per manufacturer's specifications. Model 448-43 manufactured by Dumor, www.dumor.com. Powder coated finish. Color: Bronze. Submit product data for approval. | 2/L2.2 |
| 11 | Install playground equipment, install per manufacuter`s recommendations and in accordance with all governing codes. Per quote #Q23-2281 provided by Park Planet, contact Misha Holliman (530) 852-1363. Submit product data and shop drawings for approval. | 4/L2.2 |
| 12 | Install shade structure, install per manufacuter's recommendations and in accordance with all governing codes. Per quote #Q23-2280 provided by Park Planet, contact Misha Holliman (530) 852-1363. Submit product data and shop drawings for approval. Contractor shall be responsible for all required permitting and processing. | 1/L2.3 |
| 13 | Install spray ground equipment. Include all required equipment, vaults, products and appurtenances needed for a complete, operational system to meet the intent of these plans. Mftr: Water Odyssey per quote #XXXXX provided by All About Play Inc, contact Glen Wurster (916) 923-2180. Submit product data and shop drawings for approval and as required for County/City permitting. Contractor responsible for all permitting and processing required. | 1/L2.6 |
| 14 | Install 6" vertical curb at upslope side of paving. | 2/L2.1 |
| 15) | Install fitness equipment structure. Model: 2-Person Back and Arms Combo SGR042 Manufacturer: Greenfields Outdoor Fitness, Inc, www.gfoutdoorfitness.com. Submit product data for approval. Install per manufacturer's guidelines and printed instructions. | 1/L2.4 |
| 16 | Install fitness equipment structure. Model: 4-Person Pendulum, Abs, & Dip Station SGR022. Manufacturer: Greenfields Outdoor Fitness, Inc, www.gfoutdoorfitness.com. Submit product data for approval. Install per manufacturer`s guidelines and printed instructions. | 1/L2.4 |
| 17 | Install fitness equipment structure. Model: Plyometric Steps (Set of 3) SHP724 Manufacturer: Greenfields Outdoor Fitness. Inc. | 1/L2.4 |

www.gfoutdoorfitness.com. Submit product data for approval. Install per manufacturer's guidelines and printed instructions. Install fitness equipment structure. Model:2-Person Cross-Country Skit 1/L2.4 SGR026. Manufacturer: Greenfields Outdoor Fitness, Inc, www.gfoutdoorfitness.com. Submit product data for approval. Install per manufacturer's guidelines and printed instructions. Install park sign. Model: #70 with bubble top and footing. Mftr: Outdoor 5/L2.2 Creations, Inc. www.outdoorcreatons.com, (530) 365-6106. Submit shop drawings for approval. Park name spelling and final layout for signage shall be approved by the City prior to ordering sign. 4/L2.5 Install tube steel screen fence at equipment enclosure. 1/L2.5 Install chain link fence at project perimeter. Submit shop drawings for Install decorative metal fence at project perimeter. Submit shop drawings 2/L2.5

Install double gate at spray ground equipment enclosure. Match design of adjacent fence. Submit shop drawings for approval.

SHP724 Manufacturer: Greenfields Outdoor Fitness, Inc,

Install double gate at decorative metal fence. Match design of adjacent 3/L2.5 fence. Submit shop drawings for approval. 4/L2.5 04 May 2023 Checked:

1 Addendum 1 5/25/23

Sam Harned

Landscape

Architecture

PO Box 2275 Oakdale, CA 95361 209-380-7376

www.harnedla.com

Prepared for:

City of Lathrop


(209) 941-7200

Lathrop, CA 95330


390 Towne Centre Drive

22-021 Project No.: 1" = 20'-0"

1. See Sheet L0.2 for site construction notes.

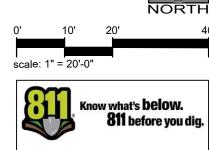

Construction Plan

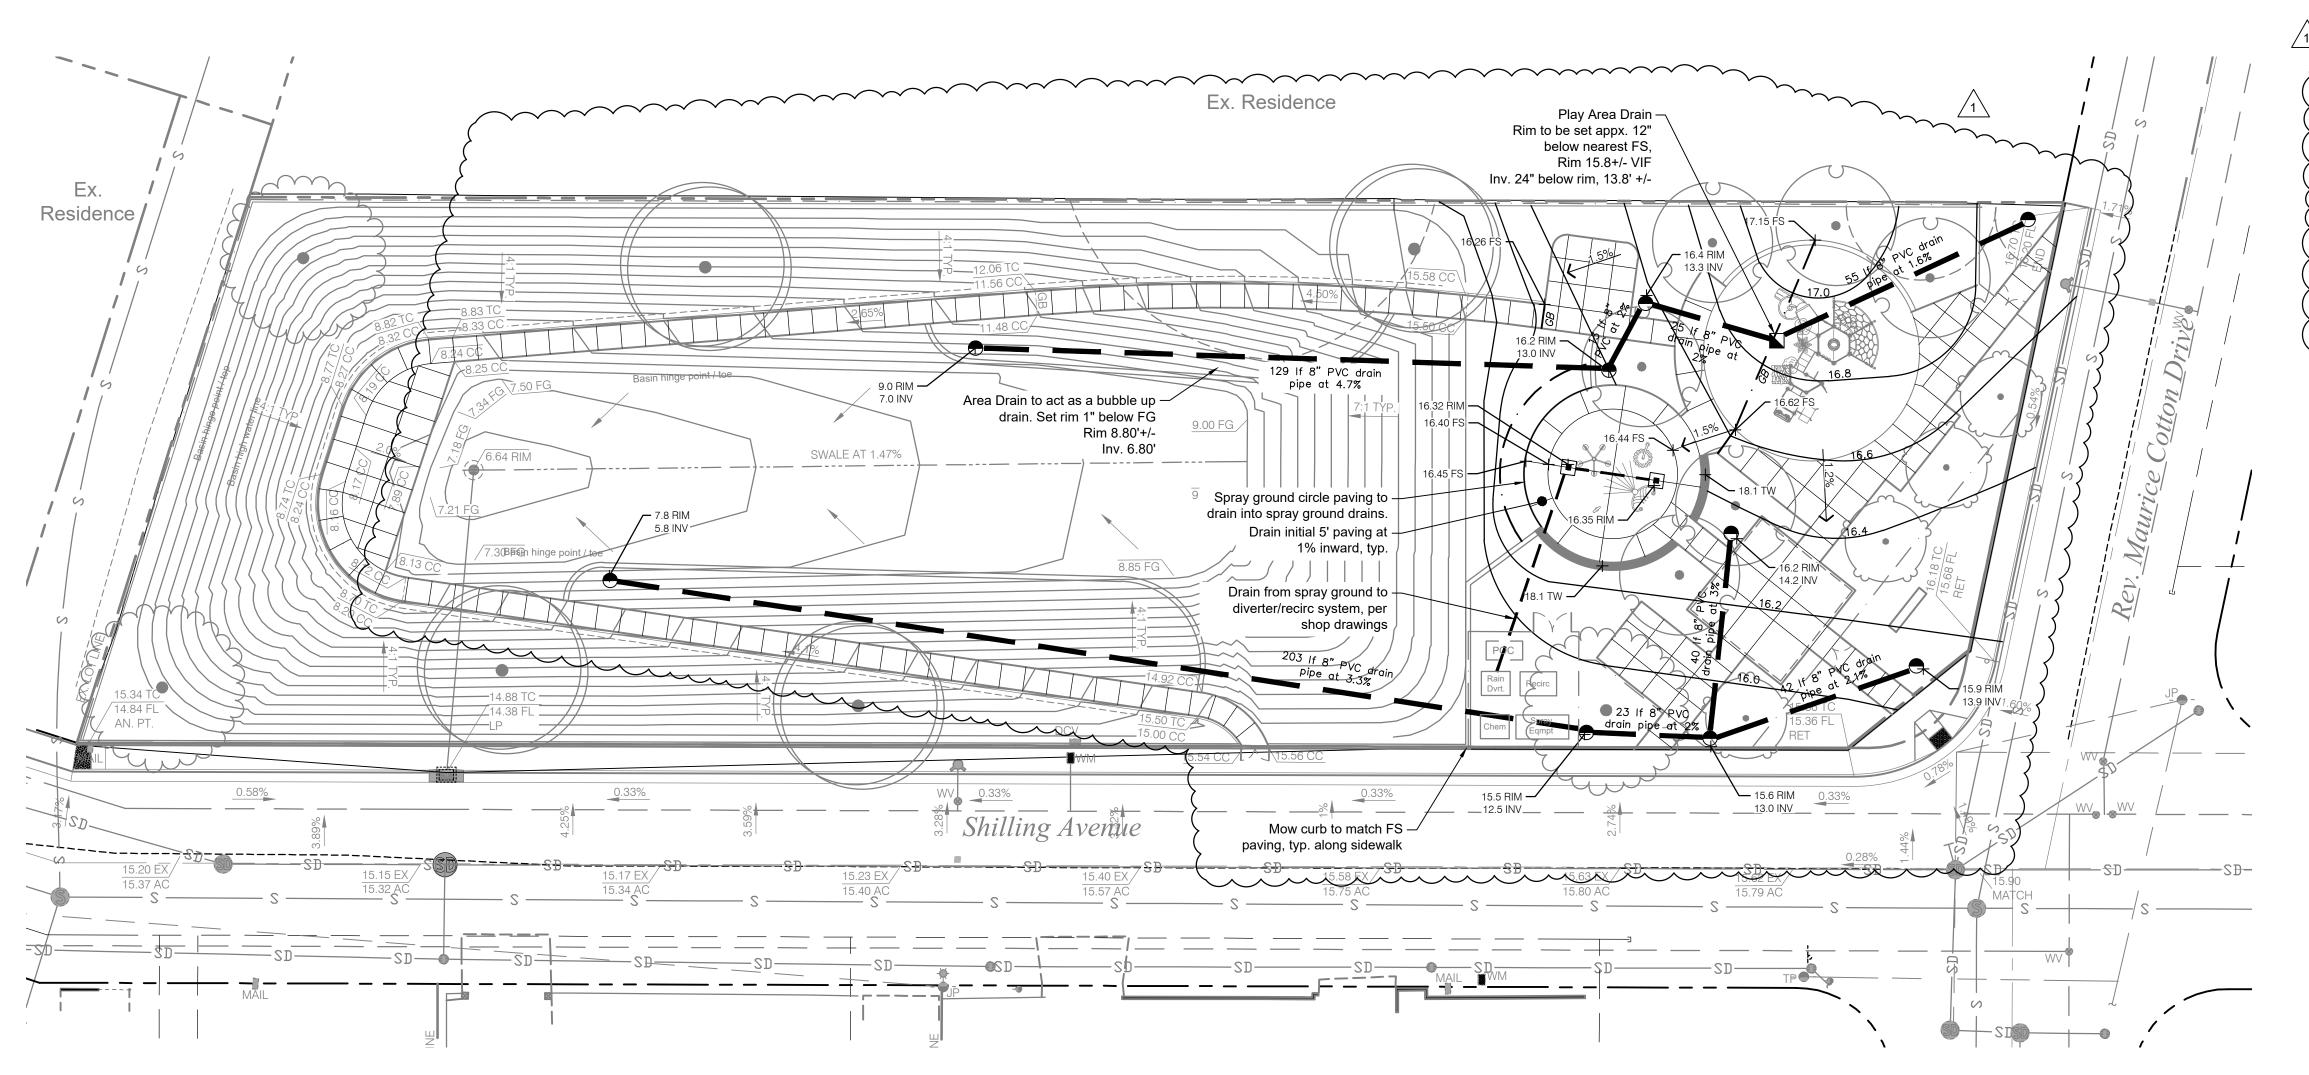

DRAINAGE SYMBOL LEGEND

Symbol Item Des

Play Area Drain, see Detail 2 / Sheet L2.4. Submit product data for approval. Conform to City Standards.

Area Drain, see Detail 3 / Sheet L2.4. Submit product data for approval. Conform to City Standards.

Spray Ground Drain, Plain Drain per mftr. Submit product data for approval. See Sheet L2.10.

PVC drain pipe, 8", min. slope 1% U.O.N.



Sam Harned Landscape Architecture PO Box 2275 Oakdale, CA 95361 209-380-7376 www.harnedla.com



Prepared for:

City of Lathrop 390 Towne Centre Drive Lathrop, CA 95330 (209) 941-7200

Proje

SHILLING PARK

Revision:
1 Addendum 1 5/25/23

Date: 04 May 2023
Drawn: RSH
Checked: RSH
Project No.: 22-021

1" = 20'-0"


Sheet:

Landscape Drainage and Grading Plan

112

Notes:

1. See Sheet L0.2 for site construction notes.

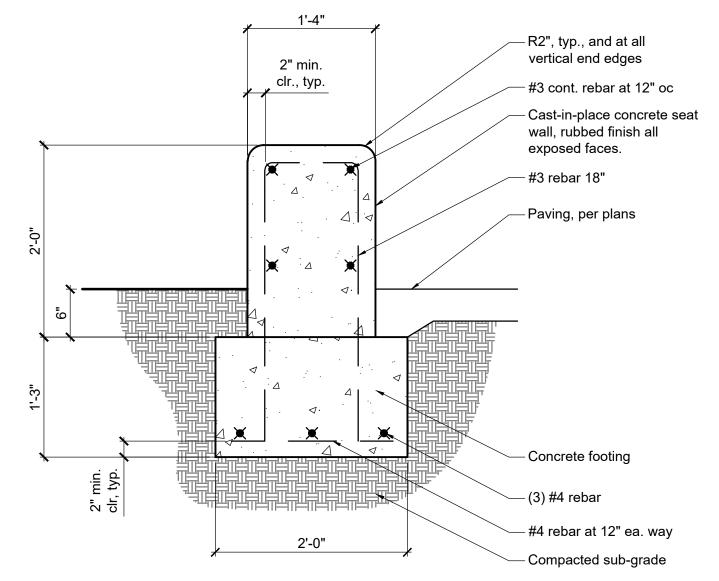

Expansion joint, full depth of paving Paving, per plans -Uphill slope, per grading plans - Vertical curb, install per detail or applicable City Std Detail if applies Compacted subgrade

Prepared for:

City of Lathrop

(209) 941-7200

Project:

390 Towne Centre Drive

Lathrop, CA 95330

Sam Harned Landscape

Architecture

PO Box 2275 Oakdale, CA 95361 209-380-7376

www.harnedla.com

SEAT WALL - C.I.P CONCRETE

033373.13-03

VERTICAL CURB AT PAVING EDGE

Adjust FG to be flush with —

see grading design

FS at low points in grading

to allow water to flow over,

321313.13-11

329413.19-13

additional detail for color, layout,

Critical Fall Height.

and product data. Allow no ponding

-Class II aggregate,

compacted, min. 4" thick

Subgrade compacted to

95% per ASTM D1557

-SUBGRADE, 6" MIN. 95% CONCRETE PATH (ON-SITE ONLY) - #4 REBAR 24" O.C./E.W. BOTH DIRECTIONS CENTERED IN SLAB OR PER APPROVED PLANS -EXPANSION JOINT - WEAKENED PLANE JOINT REINFORCED CONCRETE PATH NOTES: 1. Some concrete paths may require thicker (class II base rock) reinforced sections to accommodate heavier maintenance EXPANSION vehicles as designated by the City JOINT 2. Concrete paths for vehicle traffic must be minimum 8' wide. PLAN VIEW

- WIDTH VARIES -

_____ 2'-3 1/2"± _____ Width, per specified product – Bolt leg to bench with S/S bolt Arm rest, qty. Back support and location as specified Mftr. prov. holes Finish surface Bench, as specified. brace, Assemble and install per mftr's recommendations. Anchor bolts, provided or as recommended by mftr.

1. Powder coat finish on all metal parts, UON. Confirm color and finish prior to ordering.

2. See Construction Callout for length of bench and any additional specification (e.g. - arm rest, backless).

Concrete mow curb, provide control joints every 5' o.c. max. See construction callout for color and finish. Finish grade — **⊇**. **⊇**. ⁻ ¾" radius, typ. ₽, ₽ - #3 rebar continuous, center in curb - Compacted subgrade, 90% min. compaction per ASTM D1557

CITY OF LATHROP
DEPARTMENT OF PUBLIC WORKS City Of Lathrop Public Works Director No Revised

---- LANDSCAPING

SLOPE CONCRETE-

SURFACE TO DRAIN $S = 1.5\% \pm 0.5\%$

NOT TO SCALE STANDARD **DETAIL** Date: JANUARY 2021

- Class II aggregate base

- Compacted subgrade

P-PA1-SHI-04

┌ 1" MIN.

BENCH - SURFACE MOUNT

MOW CURB - 12"

CONCRETE PATH - CITY STD. DETAIL R-9

Revision: 1 Addendum 1 5/25/23

Date: 04 May 2023 RSH Drawn: RSH Checked: 22-021 Project No.: As shown

Sheet: Site Construction **Details**

12 ga. steel cover Vinyl lettering steel shield TRASH BOTTLES & CAST Bolted connection $\frac{3}{8}$ " thick - steel plate receptacle to base Steel with through hole for anchor bolts Powder coat finish on all metal parts, UON. – 5"dia. steel bar Confirm color and finish prior to ordering. 2. See Construction Callout for manufacturer and Mtft-provided 3/8" x 2" steel bar anchoring system $\frac{1}{4}$ " x 1- $\frac{1}{2}$ " steel bar

curb/thickened edge, or as $-\frac{1}{2}$ " wearing course, see plan or separate pour. Paving, per plans - Cushion Layer, min. thickness to meet CPSC guidelines for slope to drain Dbl. #3 continuous rebar through curb, 2" min. clr. all directions Down-turn edge — Down-turn Paving Edge

Concrete curb #3 continuous rebar — Glue ledge, per through curb, centered main detail Edge Curb

POURED-IN-PLACE RUBBERIZED PLAYGROUND SURFACING

Concrete glue ledge, min. 4" thick —

may be monolithic with

SPLIT TRASH/RECYCLE RECEPTACLE - SURFACE MOUNT

C:\Users\User\Dropbox\SHLA\Projects\2022\22-021-Shilling Ave Park\Tasks-CAD\ConDocs\22-021-LSBase.dwg

321816.13-05

SHILLING



| ltem | Description | |
|------------------|-------------------------------------|--|
| R50AC68FA | | |
| HS-1004-R | Collars | |
| GF-7002 | Dome Cap, R5 | |
| S-1010-R5-10ft | Post, 10ft R5 | |
| S-1011-R5-11ft | Post, 11ft R5 | |
| S-1013-R5-13ft | Post, 13ft R5 | |
| S-1015-R5-15ft | Post, 15ft R5 | |
| S-1017-R5-17ft | Post, 17ft R5 | |
| S-1018-R5-18ft | Post, 18ft R5 | |
| S-1019-R5-19ft | Post, 19ft R5 | |
| S-1021-R5-21ft | Post, 21ft R5 | |
| S-1101-R5 | Square Deck | |
| S-1102-R5 | Tri-Deck | |
| S-1103-R5 | Hex Deck, Half (5 Post) | |
| S-1206-12R5 | ADA Stairs, 12in Rise w/ Walls | |
| S-1206-36R5 | ADA Stairs, 36in Rise w/ Walls | |
| S-1209-12-R5 | Transfer Station, 24in-L | |
| S-1213-3R | Climber, Firepole 30-36in | |
| S-1228-3 | Climber, Bedrock 36in | |
| S-1282-7 | Climber, Curved Rung Ladder 78-84in | |
| S-1293-R5 | Net Tower Ladder | |
| S-1301-24R5 | Wall, Steel (24in) | |
| S-1309-2-R5 | Half Walls (Pair) R5 | |
| S-1310-R5 | Transition Wall | |
| S-1360-1672-FIRE | Fire Danger Sign | |
| S-1623-DC-CAB | Fire Truck Cab | |
| Item | Description | |
| S-1623-DC-WSP | Fire Truck Wheel Seek Panel | |
| S-1672-36B | Base Rock | |
| S-1689-TSAP | Train Station Access Panel | |
| S-1689-TSTTT | Train Station Tic-Tac-Toe Panel | |

Train Station Window Panel

Train Station Window Upper Barrie

Slide, Twister Spiral 84in (L)

Metal Roof, Hex (Corrugated)

Fire Station Flag - Wavy

Evergreen Topper (Large)

Oak Topper

Center Access Hex Net Deck (96in)

Hand Spin Cycler (Post Mounted)

Open Frame


Hex Net Frame

Hex Net Bay (Deck)

Balance Step Bay (Deck)


PROJECT#: R50AC68FA


DATE: 6/30/2021 | DRAWN BY:

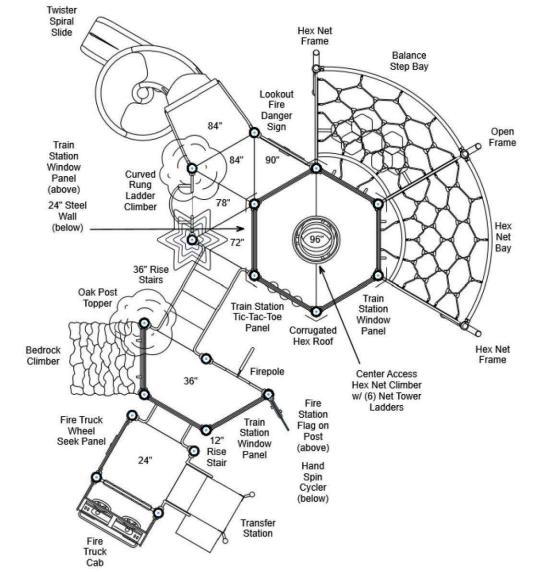

(2) Oak Post Toppers

(2) Lookout Base Rocks

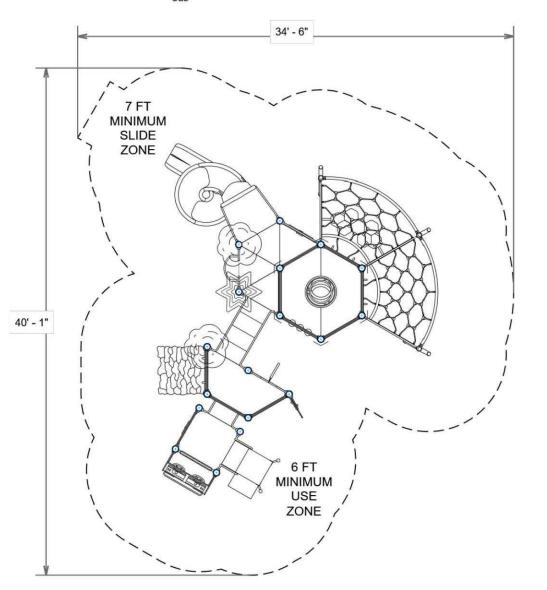

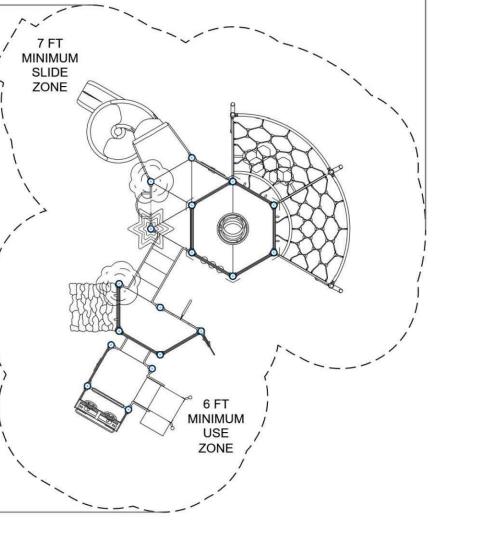

1. See construction callout legend for product, color and finish information. 2. Submit product information for approval. 3. All steel members to be powder-coated by manufacturer. 4. Use manufacturer-provided anchor bolts, ½" x 3 $\frac{3}{4}$ " or as otherwise approved.

P-PA1-SHI-02

PLAYCRAFT REP:

Playcraft Direct, Inc.

OUTDOOR CREATIONS, INC. SCALE: 1" = 24" MODEL# 705 w/BASE - FOOTING DRAWN BY: MNC Minimum below grade Add height needed above grade **ELEVATION SECTION** – 48" O.C. — 3" grout pockets

S-1689-TSW

S-1689-TSWUB

S-1706-S7L-R5

S-18031-R5

S-1820-R5-FIRE

S-1847-LR5 S-1848-R5

S-1926-LR5

S-1932-R5

S-5101

5-5104

S-5201-DL

S-5202-DL

HS-1007-R5

R50AC6FA

recommendations and in accordance with

limits of safety surfacing; inform Owner if otherwise and do not continue installation

1. Submit product data and shop drawings

all governing codes and guidelines.

3. Verify entire minimum clear zone is within

until additional direction is provided.

Representative: Park Planet

for approval.

2. Install per manufacturer's

INSTRUCTIONS FOR SIGNS WITH BASE (PIPE MOUNT) 1) Pour a concrete footing per detail. (SEE FOOTING PAGE) Make sure it is flat and level. 2) Set pipes (shipped with sign), into footing grout pockets. Do not use mortar yet as a "dry run" installation recommended. 3) Set base, if supplied with sign, over pipes and square up to footing.

4) Place sign on pipes. Do not epoxy yet as a "dry run" to check for proper fit is recommended. 5) If sign and base install properly then you can proceed to permanent installation that includes application of mortar/epoxy (not supplied by ODC). 6) Remove sign and base (if supplied) and pipes. Mix mortar and fill grout pockets ¾ full with mortar. 7) Apply construction epoxy between footing and base.

8) Reinstall pipes and set base over pipes and square up to footing. 9) Place sign on pipes and prior to contact with base apply a thick bead of construction epoxy

that runs in the center of the base (use pipes as guideline) the length of the sign itself.

10) Make any fine tuning adjustments to the sign as needed by use of shims while epoxy/mortar is setting. 11) Use rags/towels to clean up any epoxy that may squeeze out from under the sign as sign settles on base.



MIN. USE ZONE: 35' x 41'

Bench and table supports, 2" Sch 40 steel Pre-drilled anchor bolt holes in ea. corner Bench support -1. See construction callout legend for product, color and finish information. 2. Submit product information for approval. 3. All steel members to be powder-coated by manufacturer. 4. Use manufacturer-provided anchor bolts, ½" x 3 $\frac{3}{4}$ " or as otherwise approved.

Bike rack, shape may vary from - Bike rack, qty and shown based on model per plan specified product. See Reference Install racks plumb Schedule for product and square to paving information. → Path of walkway — → Bike Rack Layout Surface mount using anchor bolts supplied by, or as recommended by, manufacturer. Paving, per plans –

BIKE RACK - SURFACE MOUNT

30" when located at open

paving, 36" min


from walls 36", cont.

Edge of paving,

wall, or other

built element

129313-01

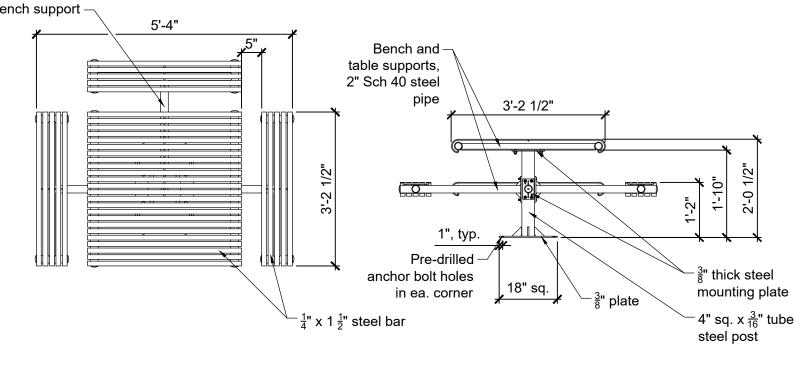

PICNIC TABLE - ADA ACCESSIBLE

129343.53-07

3'-2 1/2" Revision: 1 Addendum 1 5/25/23 ਫ਼ੇ" thick steel mounting plate ⁻ 4" sq. x ³/₁₆" tube steel post Date:

129343.53-06

04 May 2023 RSH Drawn: RSH Checked: 22-021 Project No.: As shown

Sam Harned

Landscape

Architecture

PO Box 2275 Oakdale, CA 95361 209-380-7376 www.harnedla.com

Prepared for:

City of Lathrop

Project:


PARK

SHILLIN

390 Towne Centre Drive

Lathrop, CA 95330 (209) 941-7200

Sheet: Site Construction Details

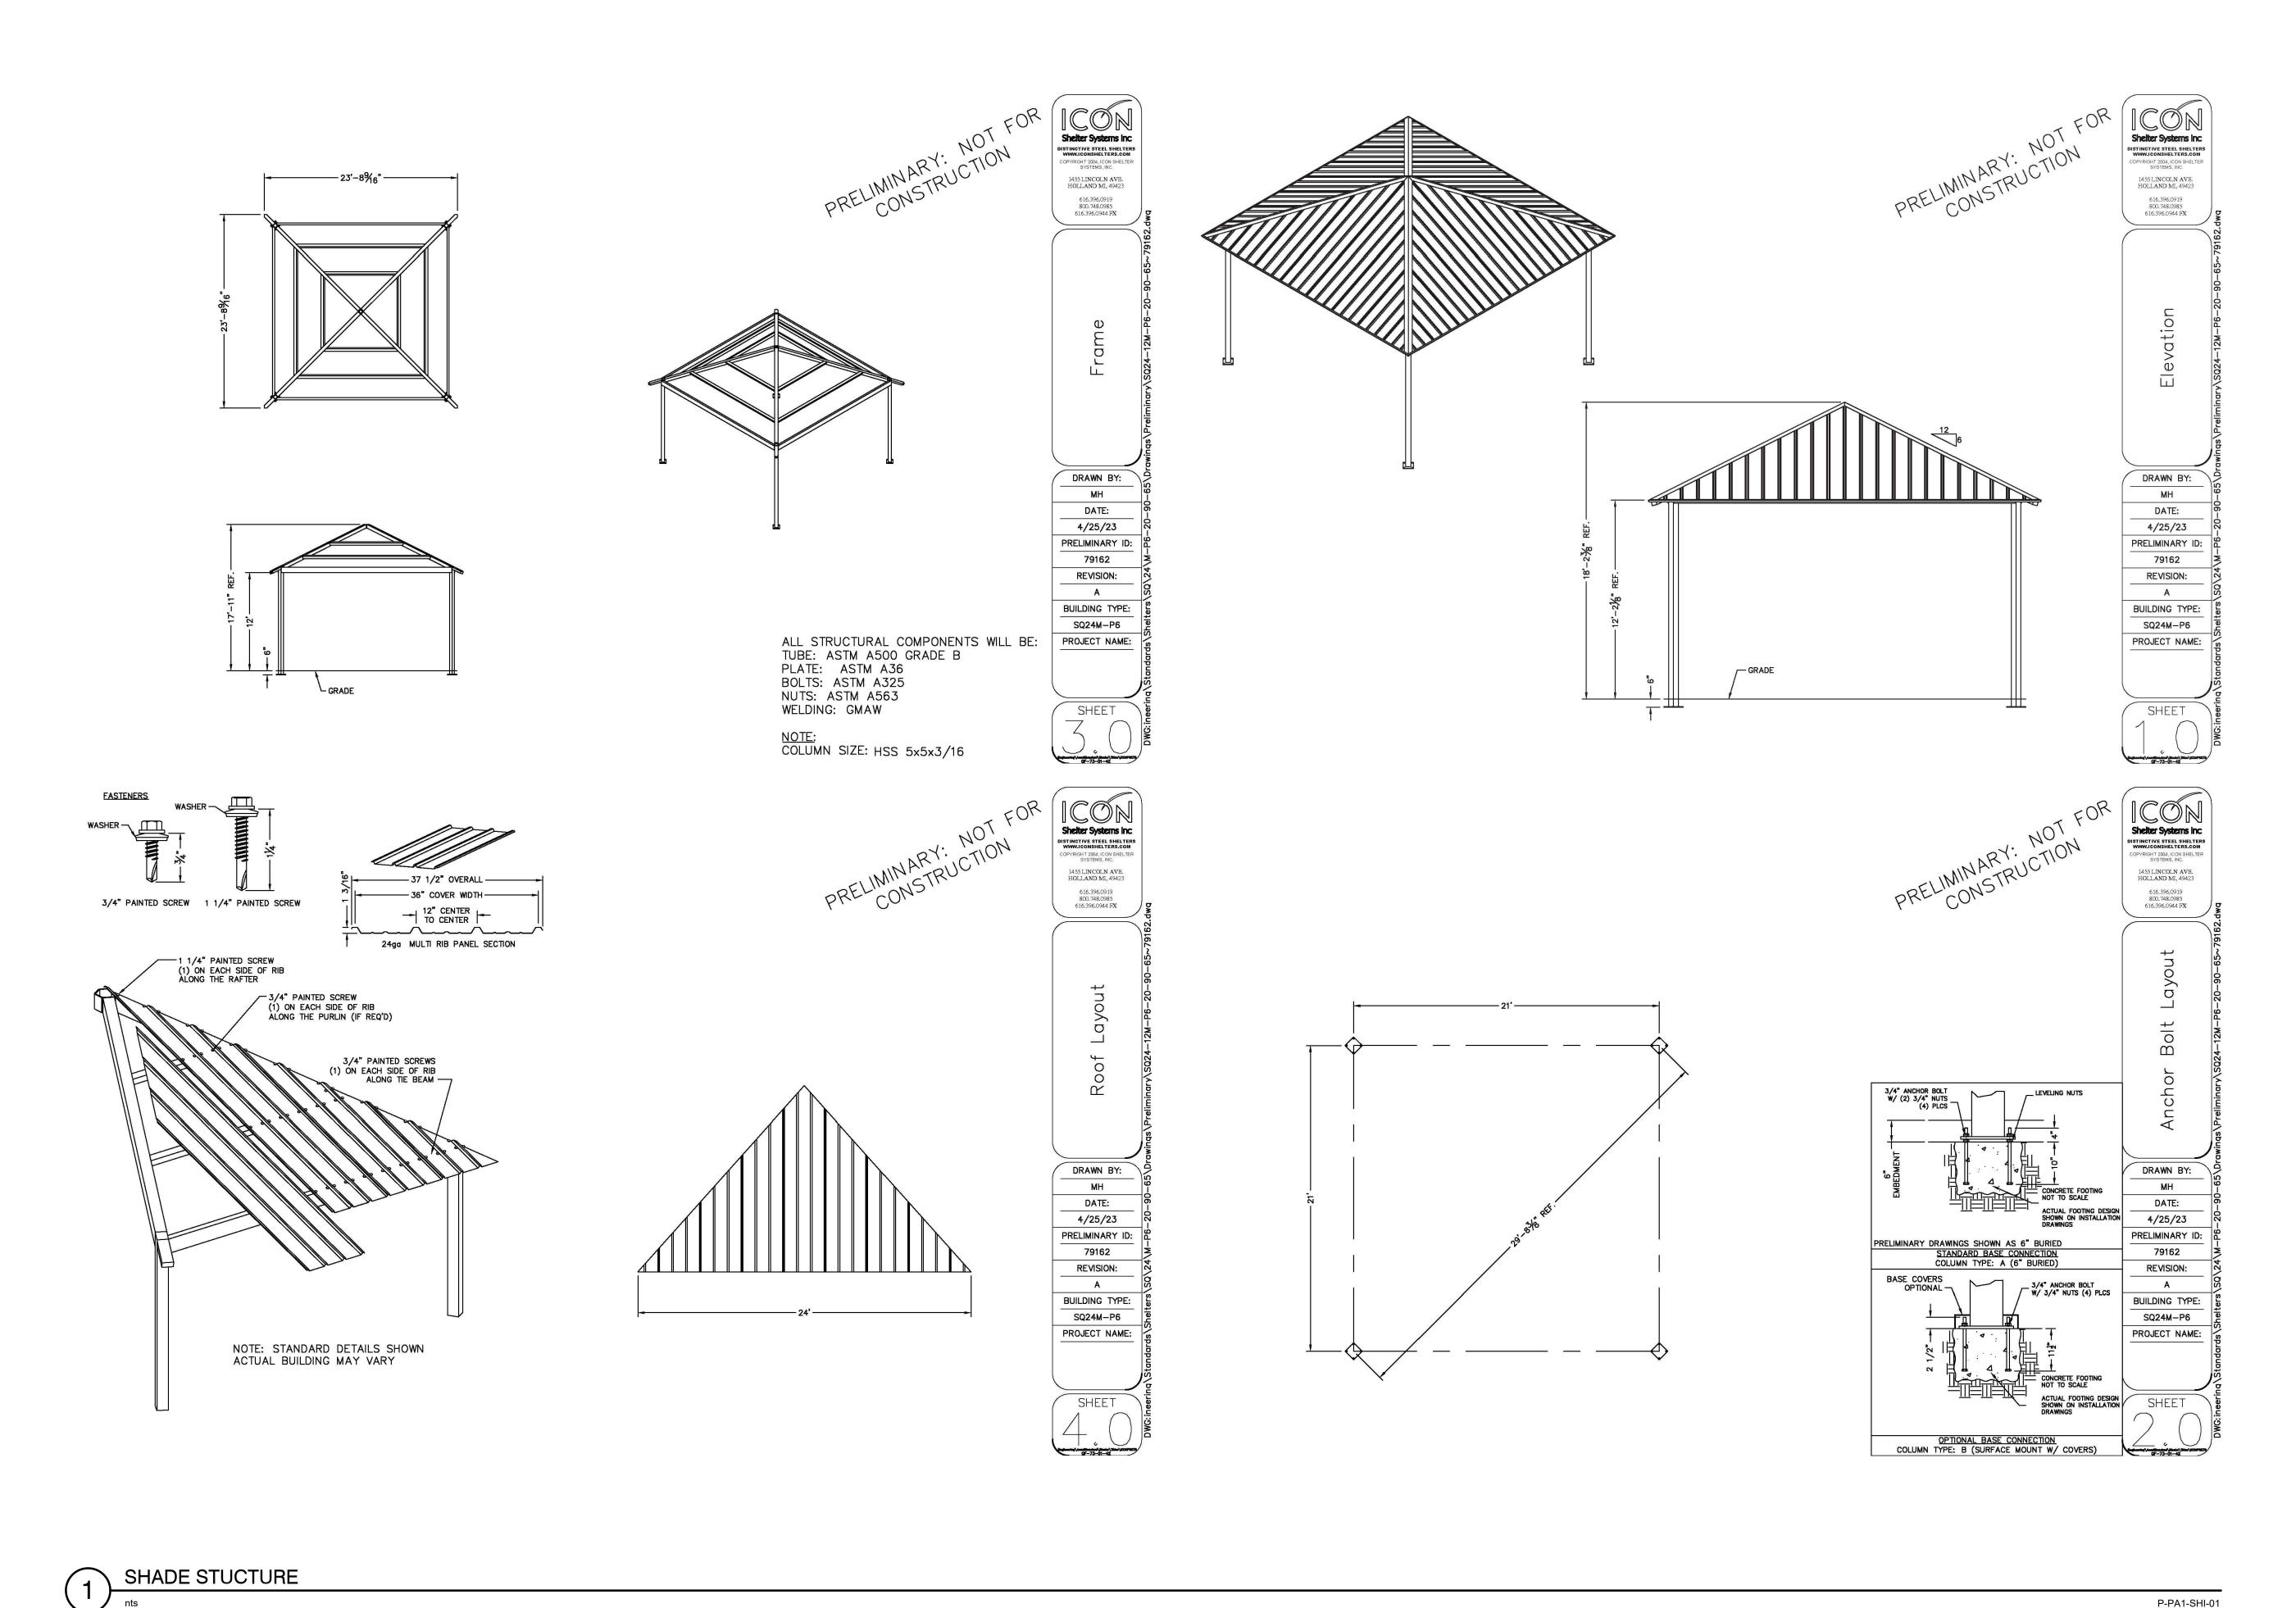

Sam Harned
Landscape
Architecture
PO Box 2275
Oakdale, CA 95361
209-380-7376
www.harnedla.com



Prepared for:

City of Lathrop
390 Towne Centre Drive
Lathrop, CA 95330
(209) 941-7200

Project:


SHILLING PARK

Revision:
1 Addendum 1 5/25/23


Date: 04 May 2023
Drawn: RSH
Checked: RSH
Project No.: 22-021
Scale: As shown


Site
Construction
Details

L2.3

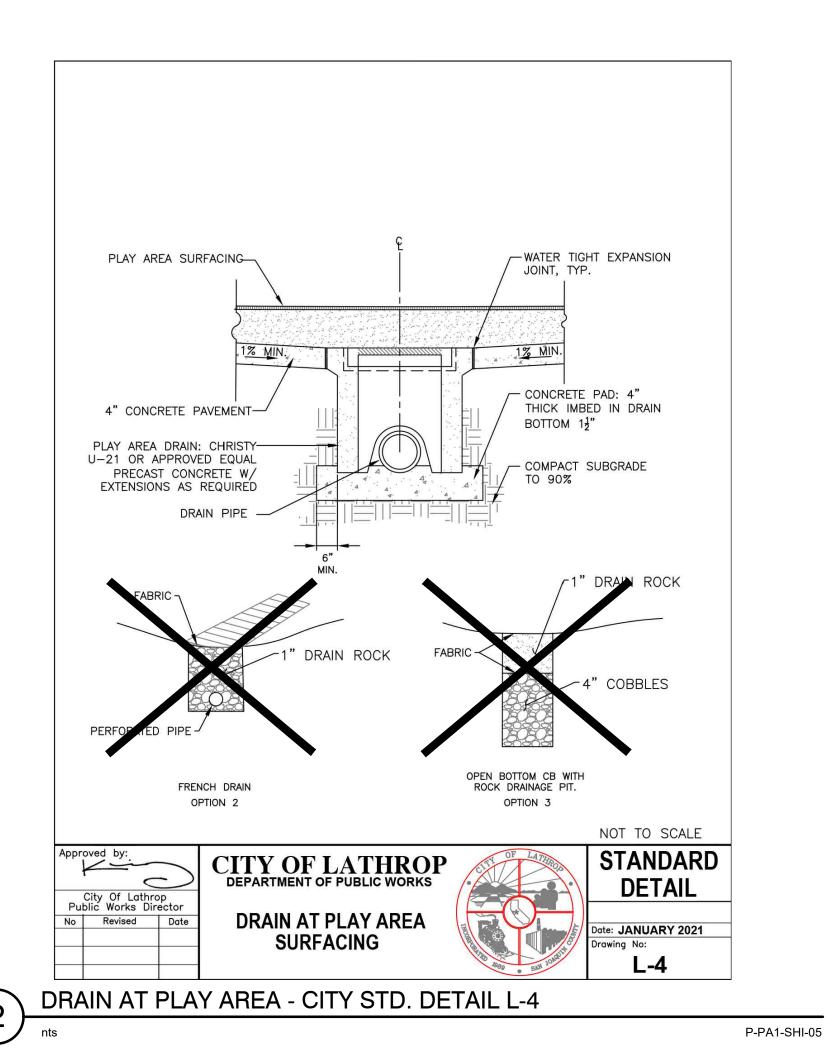



GREENFIELDS OUTDOOR FITNESS 2617 W. WOODLAND DR. ANAHEIM, CA 92801 PHONE: (888) 315-9037 EMAIL: info@greenfieldsfitness.com www.greenfieldsfitness.com AREA OF CONCRETE PAD: 33 SQ FT → 8" THICKNESS FOR LOOSE SURFACE INSTALLATION. 6" THICKNESS FOR HARD SURFACE INSTALLATION. MINIMUM STANDALONE PAD SIZE <u>DETAIL A</u> PLAN VIEW ~ 2" STOPPER PLATE **BELOW SEAT** SIDE ELEVATION FRONT VIEW 1. INSTALLATION TO BE COMPLETED IN ACCORDANCE WITH MANUFACTURER'S SPECIFICATIONS. DO NOT SCALE DRAWING. 3. THIS DRAWING IS INTENDED FOR USE BY ARCHITECTS, ENGINEERS, CONTRACTORS, CONSULTANTS AND DESIGN PROFESSIONALS FOR PLANNING PURPOSES ONLY. THIS DRAWING MAY NOT BE USED FOR CONSTRUCTION. 4. ALL INFORMATION CONTAINED HEREIN WAS CURRENT AT THE TIME OF DEVELOPMENT BUT MUST BE REVIEWED AND APPROVED BY THE PRODUCT MANUFACTURER TO BE CONSIDERED ACCURATE. 5. CONTRACTOR'S NOTE: FOR PRODUCT AND COMPANY INFORMATION VISIT www.CADdetails.com/info AND ENTER REFERENCE NUMBER 4913-009. LEGACY SERIES & SIGNATURE ACCESSIBLE MODEL (SGR042) 2-PERSON BACK & ARMS COMBO REVISION DATE 19/05/2022 PROTECTED BY COPYRIGHT @2022 CADDETAILS.COM LTD

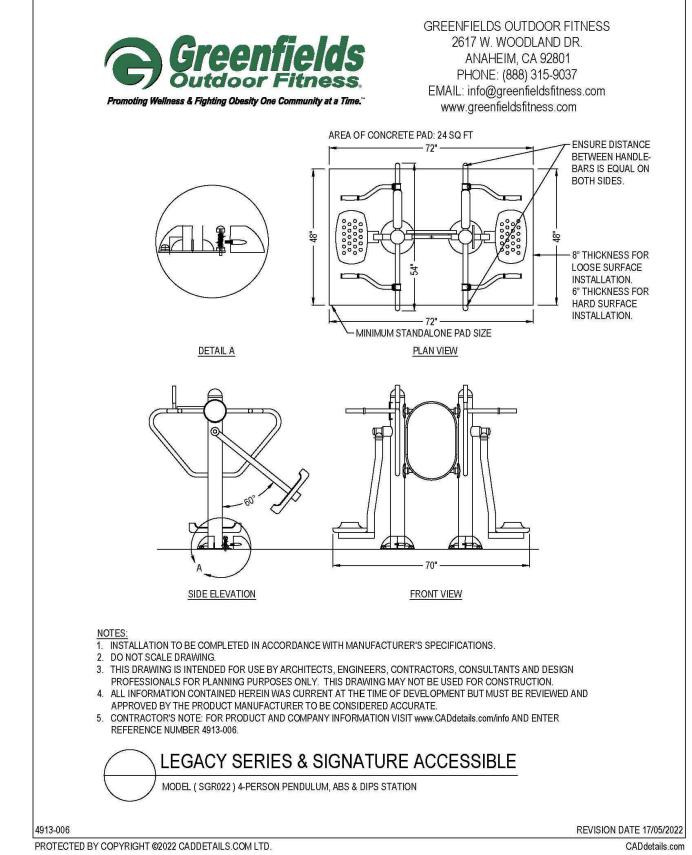


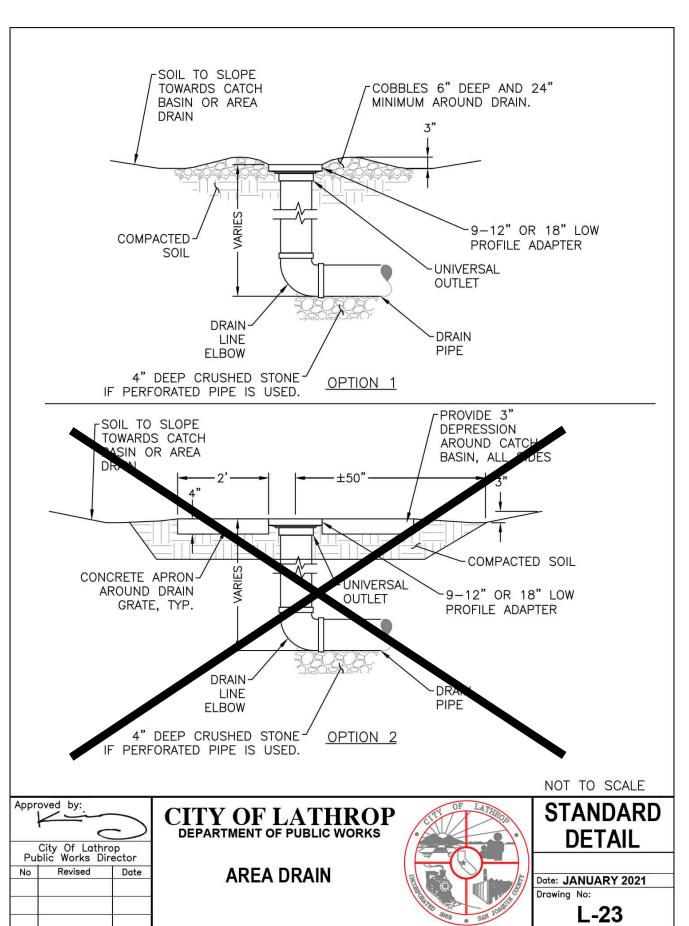

AREA DRAIN - CITY STD. DETAIL L-23

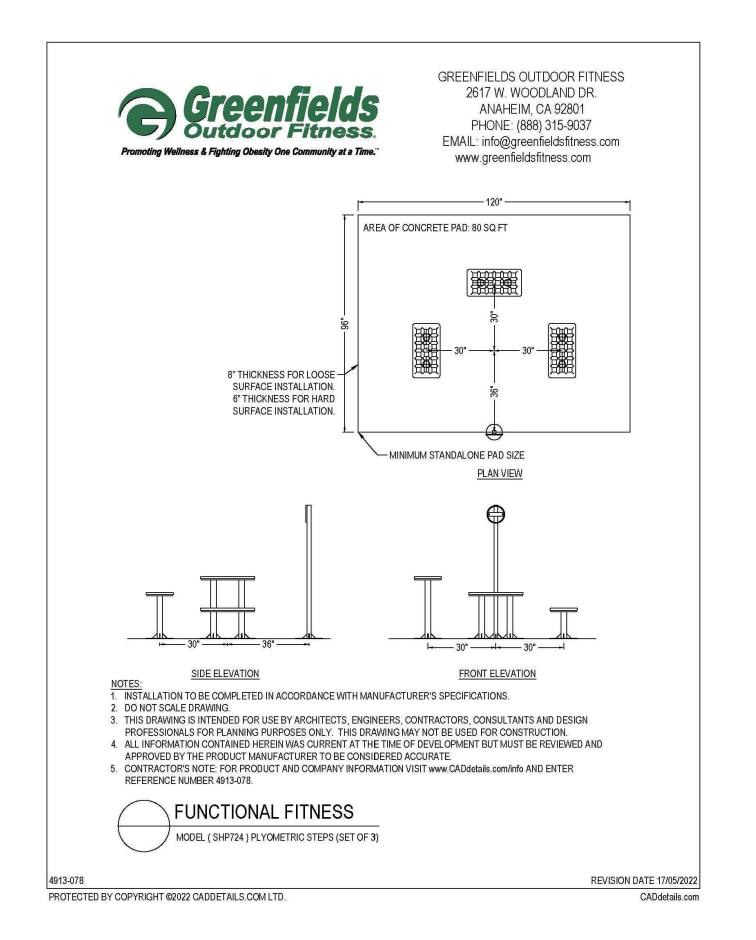

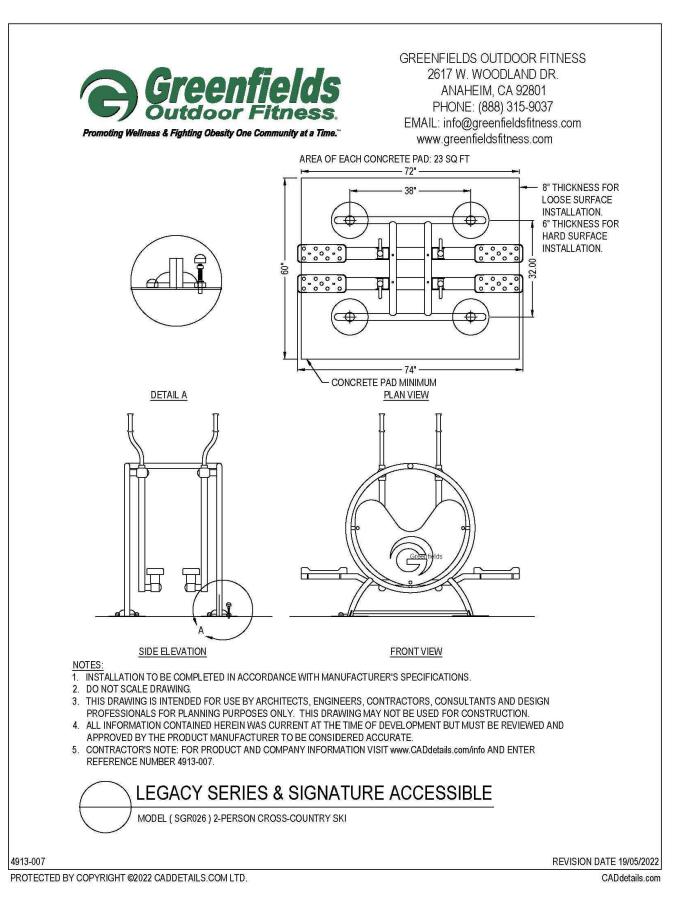

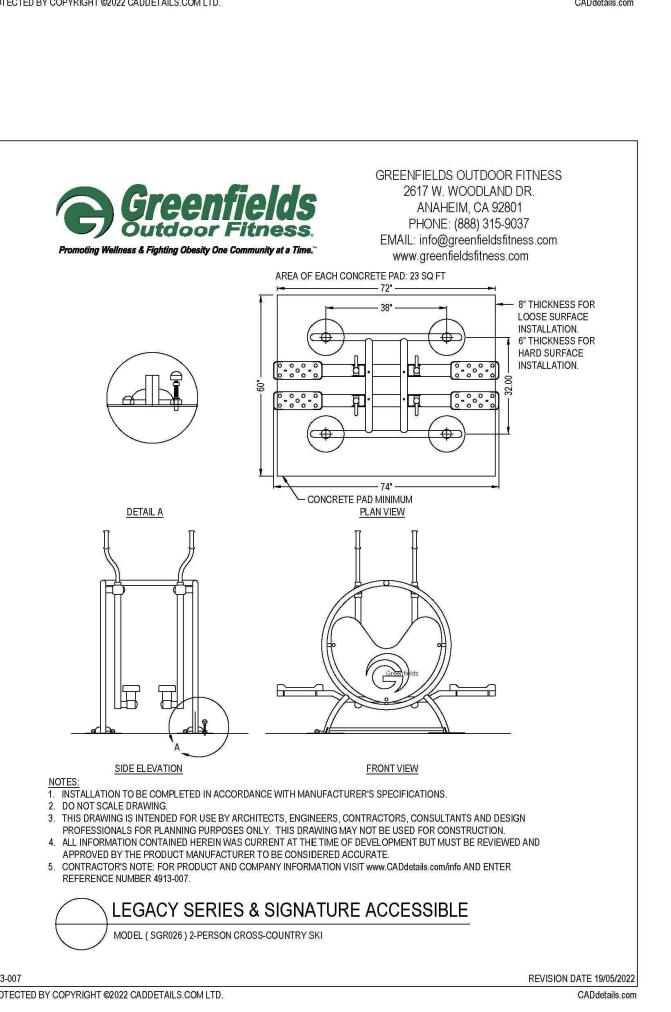

Date: 04 May 2023 RSH RSH Checked: 22-021 Project No.: As shown

Sam Harned

Landscape

Architecture

PO Box 2275

Oakdale, CA 95361

www.harnedla.com

2 0 9 - 3 8 0 - 7 3 7 6

Prepared for:

City of Lathrop

Project:

HILLIN

S

Revision:

1 Addendum 1 5/25/23


390 Towne Centre Drive Lathrop, CA 95330 (209) 941-7200

Sheet: Site Construction Details

P-PA1-SHI-20

L2.4

OUTDOOR EXERCISE EQUIPMENT

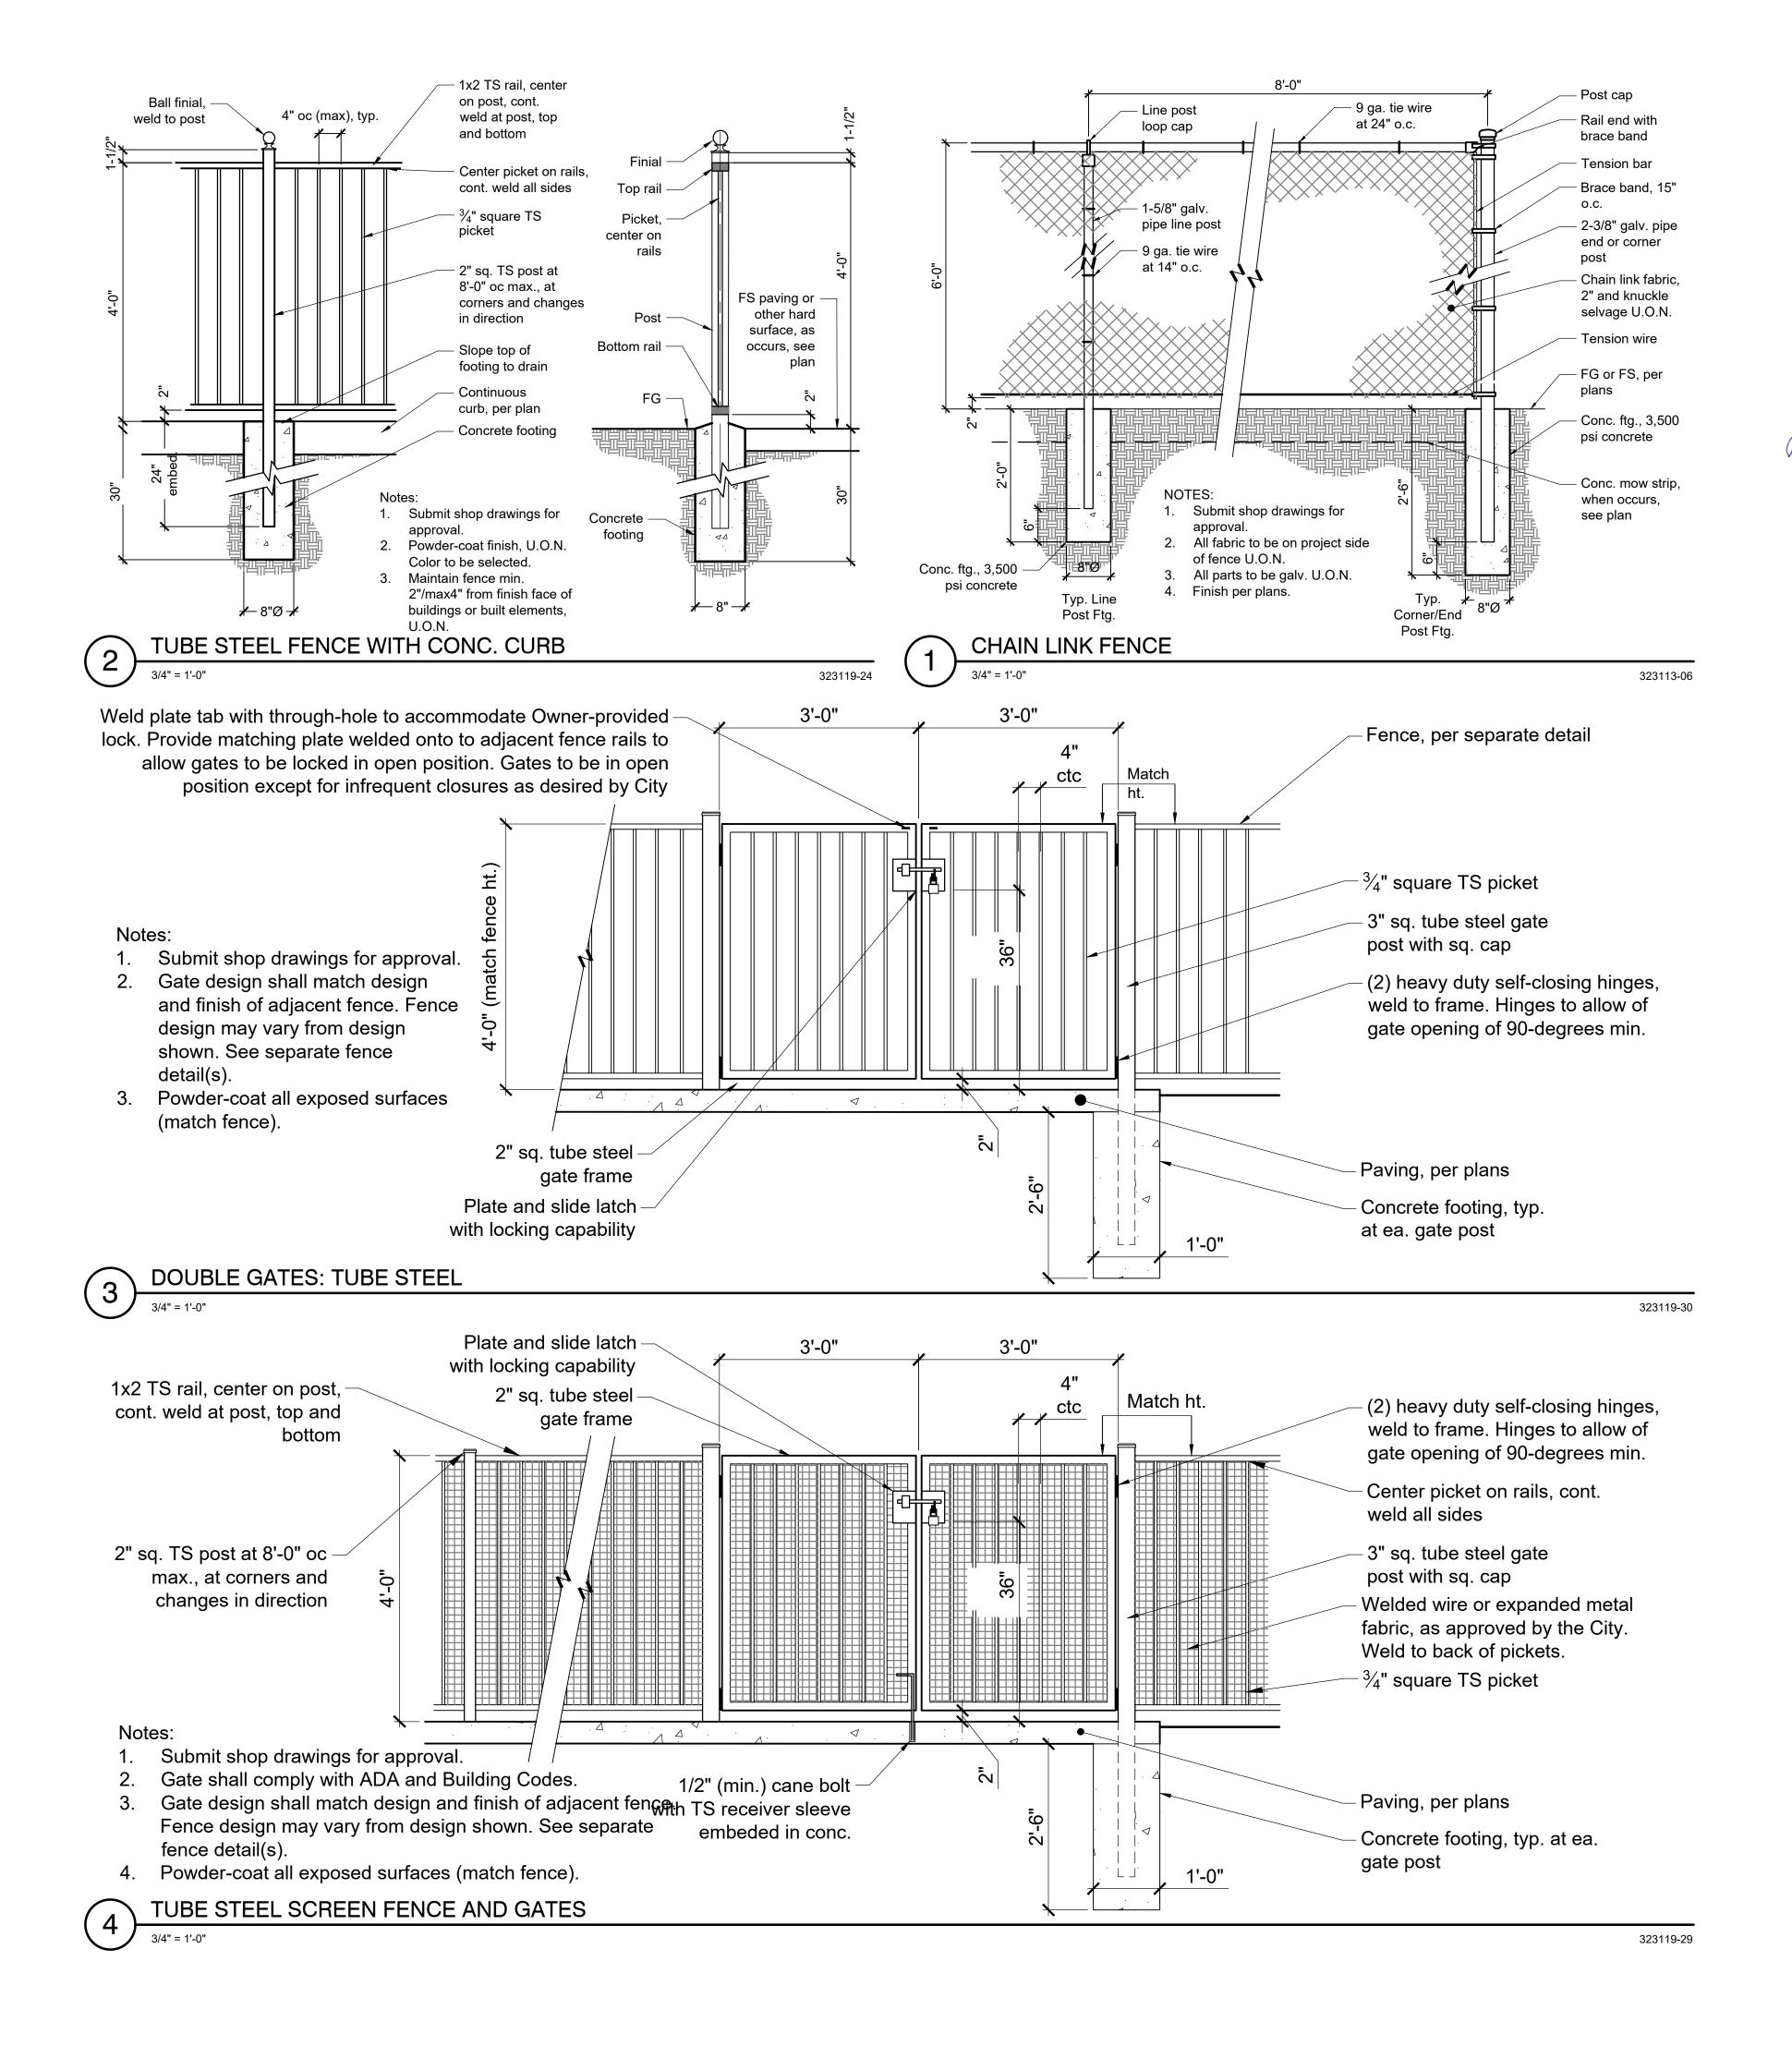

C:\Users\User\Dropbox\SHLA\Projects\2022\22-021-Shilling Ave Park\Tasks-CAD\ConDocs\22-021-LSBase.dwg





www.harnedla.com

Prepared for:

City of Lathrop
390 Towne Centre Drive
Lathrop, CA 95330

(209) 941-7200

Project:

SHILLING PARK

Revision:
1 Addendum 1 5/25/23


Date: 04 May 2023
Drawn: RSH
Checked: RSH
Project No.: 22-021
Scale: As shown

Site
Site
Construction
Details

L2.5

SHILLING PARK

LATHROP, CA. 95330

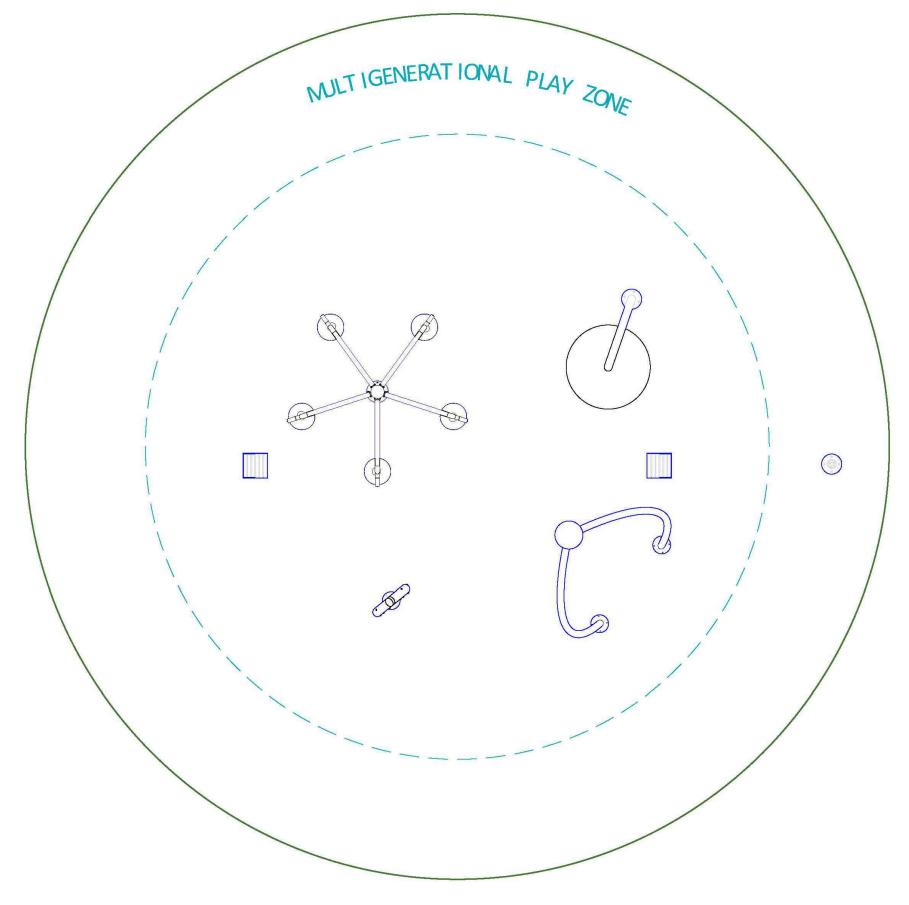



4600 HWY 123, SAN MARCOS, TX 78666 USA TEL: (512) 392-1155 WWW.FOUNTAINPEOPLE.COM FAX: (512) 392-1154

| | DRAWING SHEET INDEX | | |
|----------------|------------------------|-----------|-----|
| SHILLING PARK | | | |
| DRAWING NAME | DRAWING DESCRIPTION | DATE | REV |
| W80474-CS-V1-R | COVER SHEET | 4/28/2023 | - |
| W80474-PV-V1-R | PLAN VIEW | 4/28/2023 | 1-1 |
| W80474-PD-V1-R | PIPING & MECH. DIAGRAM | 4/28/2023 | - |
| W80474-C1-V1-R | COMPONENT SHEET 1 | 4/28/2023 | - |
| W80474-C2-V1-R | COMPONENT SHEET 2 | 4/28/2023 | - |

PRELIMINARY- NOT FOR CONSTRUCTION

SPRAY GROUND NOTES

- 1. The spray ground shown in these plans may not include all components necessary for a complete and functional installation. Contractor shall contact the supplier for the required products and contractor shall provide all equipment, fittings, piping, accessories and appurtenances required for a full and complete installation.
- 1.1. Basis of Design manufacturer: Water Odyssey1.2. Contract Glen Wurster with All About Play Inc, (916) 417-8389
- Submit complete shop drawings for approval. Shop drawings shall be suitable for submittal and approval for all agencies having jurisdiction for this element (e.g. County Health Department).
 Spray ground shall be installed in conformance with manufacturer's recommendations,
- guidelines and requirements.
 The spray ground includes, generally, the following elements. All elements shall be provided by the same manufacturer and supplier (Basis of Design provided above):
 - 4.1. Spray ground play equipment with activator
- 4.2. Piping manifold and piping4.3. Controller system / timer panel
- 4.4. Water storage reservoir (to be installed underground)
- 4.5. Rain diverter
- 4.6. Water re-circulation system
- 4.7. On-slab clam-shell cover for pad mounted manifold and equipment4.8. Drainage system





Prepared for:

City of Lathrop
390 Towne Centre Drive

Lathrop, CA 95330 (209) 941-7200

Project

SHILLING PARK

Revision:
1 Addendum 1 5/25/23

Date: 04 May 2023
Drawn: RSH
Checked: RSH

Checked: RSH
Project No.: 22-021
Scale: As shown


Site Construction Details

126

P-PA1-SHI-22

SPRAY GROUND / SPLASH PAD

| REF. ITEM FI A W103 B W003 | | FEATURE DESCRIPTION | QTY |
|----------------------------|------------------------------------|--|-----|
| | | FILL N' SPILL 5-15 GPM @ 6 PSI | 1 |
| | | CURVY COOL 14 GPM @ 20 PSI | 1 |
| С | W355 | LOTUS PETAL 12 GPM @ 6 PSI | 1 |
| D | W128 | FLOWER SHOWER 20-40 GPM @ 6 PSI | 1 |
| Е | W009 | TOUCH N' GO HARD-WIRED | |
| F W200 | | PLAIN DRAIN 50 GPM FLOW RATE EA | 2 |
| SPL | TAL GPM: ASH PAD A TAL AREA: | 81 GPM REA: 531 SQ. FT 1018 SQ. FT | |

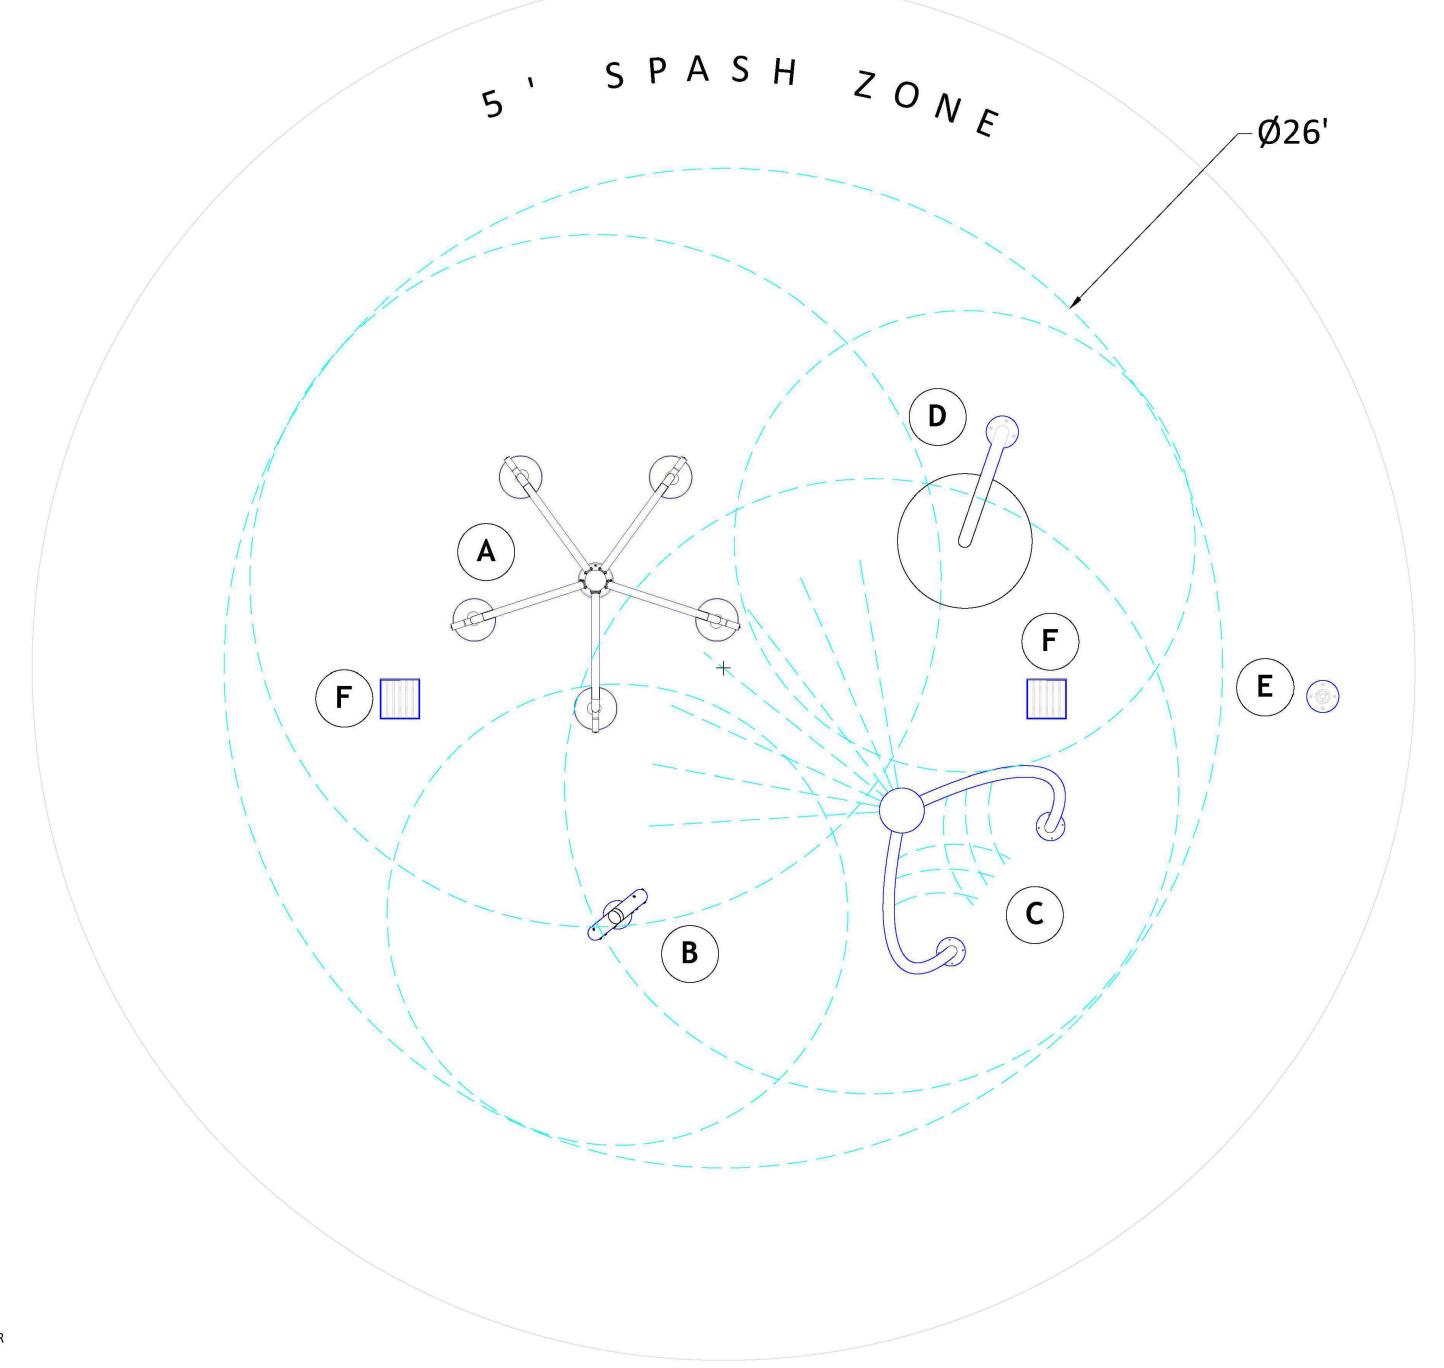



1. THIS DRAWING IS DIAGRAMMATIC IN NATURE. LOCATIONS RECOMMENDED FOR PLAY COMPONENTS AND DRAINS ARE APPROXIMATE. PIPING AND CONDUIT RUNS ARE SCHEMATIC. JOB CONDITIONS AND LOCAL CODES MUST DETERMINE FINAL ROUTING.

2. WET DECK AREA MUST BE POURED AND FORMED SO THAT WATER SHED AREA SLOPES TOWARD DRAINS.

SCALE: 1/2" = 1'-0"

Sam Harned
Landscape
Architecture
PO Box 2275
Oakdale, CA 95361
209-380-7376
www.harnedla.com



W80474 ₽ 4/28/23 rcos, Texas 78667-0807 erodyssey.com

W804

SPRAY GROUND / SPLASH PAD

JND
JND
SALES SHEET

Prepared for:

City of Lathrop
390 Towne Centre Drive
Lathrop, CA 95330
(209) 941-7200

Project:


SHILLING PARK

Revision:
1 Addendum 1 5/25/23


Date: 04 May 2023
Drawn: RSH
Checked: RSH
Project No.: 22-021
Scale: As shown

Site
Construction
Details

127

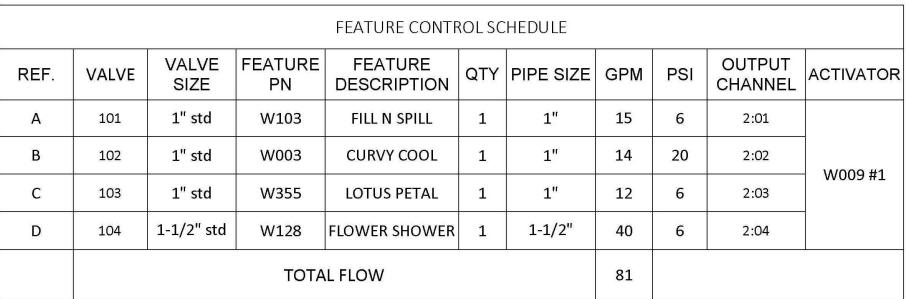

| TPUT NNEL | ACTIVATOR | |
|--------------|-----------|----------------------|
| :01 | - W009 #1 | Г |
| :02 | | |
| :03 | | CITY WATER SUPPLY |
| :04 | | ALOTTED GPM |
| | | |
| | | |
| | | |

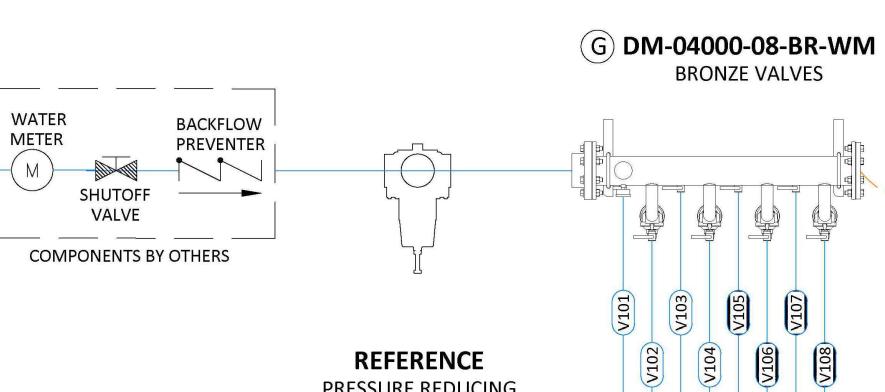

PRESSURE REDUCING

VALVE

POWER SUPPLY 120V,1Ø,60HZ 16 AMPS BY OTHERS

DSC-8-8
SEQUENCING
CONTROLLER



Sam Harned Landscape

Architecture
PO Box 2275
Oakdale, CA 95361
209-380-7376

www.harnedla.com

Prepared for: City of Lathrop

390 Towne Centre Drive Lathrop, CA 95330 (209) 941-7200

Project:

PARK

Revision:

1 Addendum 1 5/25/23

04 May 2023

Date: RSH Checked: 22-021 Project No.: As shown

Construction Details

Sheet:

EQUIPMENT CONTROL SCHEDULE PRODUCT PRODUCT DESCRIPTION QTY TOUCH N' GO HARD WIRED PLAIN DRAIN 50 GPM FLOW RATE EA REFERENCE PRESSURE REDUCING VALVE DISTRIBUTION MANIFOLD 4" -**BRONZE VALVES - WALL MOUNT** SEQUENCING CONTROLLER DSC-8-8

| - | | | | | |
|----------------------------|-----|----------------------------|---------|-------------------|--|
| ACTIVATOR CONTROL SCHEDULE | | | | | |
| REF. | # | FROM (INPUT CHANNEL) | то | OUTPUT CHANNEL | |
| Е | 011 | 1:01 | W009 #1 | 3 (3/4" | |

ACTIVATOR 011 LABEL ACTIVATOR W009 TOUCH N' GO HARD UCATION WIRED MANIFOLD **VALVE** V101 THRU V108 **ASSEMBLY**

LABEL

PLAY SCENARIO ZONES

PROGRAM NOT SPECIFIED

GENERAL NOTES:


- 1. THIS DRAWING IS SCHEMATIC IN NATURE. LOCATIONS RECOMMENDED FOR PLAY COMPONENTS AND DRAINS ARE APPROXIMATE. PIPING AND CONDUIT RUNS ARE SCHEMATIC. 2. CHECK LOCAL CODES FOR PIPING REQUIREMENTS. JOB CONDITIONS AND LOCAL CODES MUST DETERMINE
- FINAL ROUTING. 3. REFER TO THE INSTALLATION DRAWING OF EACH PLAY FEATURE AND EQUIPMENT VAULT OR UTILITY BOX FOR SPECIFIC INSTALLATION DETAILS.
- 4. PIPING, CONDUIT, AND WIRE ARE BY INSTALLER. 5. ANY REQUIRED BACKFLOW DEVICE OR WATER METER ON THE CITY WATER MAIN SHALL BE PROVIDED BY
- 6. PIPE SIZES ASSUME 100' MAXIMUM RUNS. LONGER RUNS MUST BE EVALUATED BY WATER ODYSSEY.
- CONTRACTOR RESPONSIBLE FOR VERIFICATION OF PIPE SIZE BETWEEN DISCHARGE MANIFOLD AND FEATURES. VELOCITY NOT TO EXCEED 8FT/SECOND.
- 7. A MAXIMUM OF 50 PSI @ PROVIDED MANIFOLD. 8. SYMBOL "*" INDICATES THAT THE TEE MUST BE PLACED IN THE CENTER OF THE PIPING RUN TO ENSURE
- BALANCED FLOW. 9. WET DECK AREA MUST BE POURED AND FORMED SO THAT WATER SHED AREA SLOPES TOWARD DRAINS. 10. ALL PIPING TO FEATURES ARE RECOMMENDED TO HAVE 1%-2% SLOPE FOR WINTERIZATION.

1. REFER TO ELECTRICAL SCHEMATICS AND PROGRAMMING SHEET FOR WIRING CONNECTIONS TO BE MADE TO

TAGGED SOLENOID VALVE ASSEMBLIES"

EQUIPMENT ROOM NOTES

1. LOCATION AND ORIENTATION OF EQUIPMENT ROOM AND EQUIPMENT BY OTHERS. SEE NOTE #6. 2. LOCATION OF COMPONENTS INSIDE ENCLOSURE MAY DIFFER FROM THIS LAYOUT.

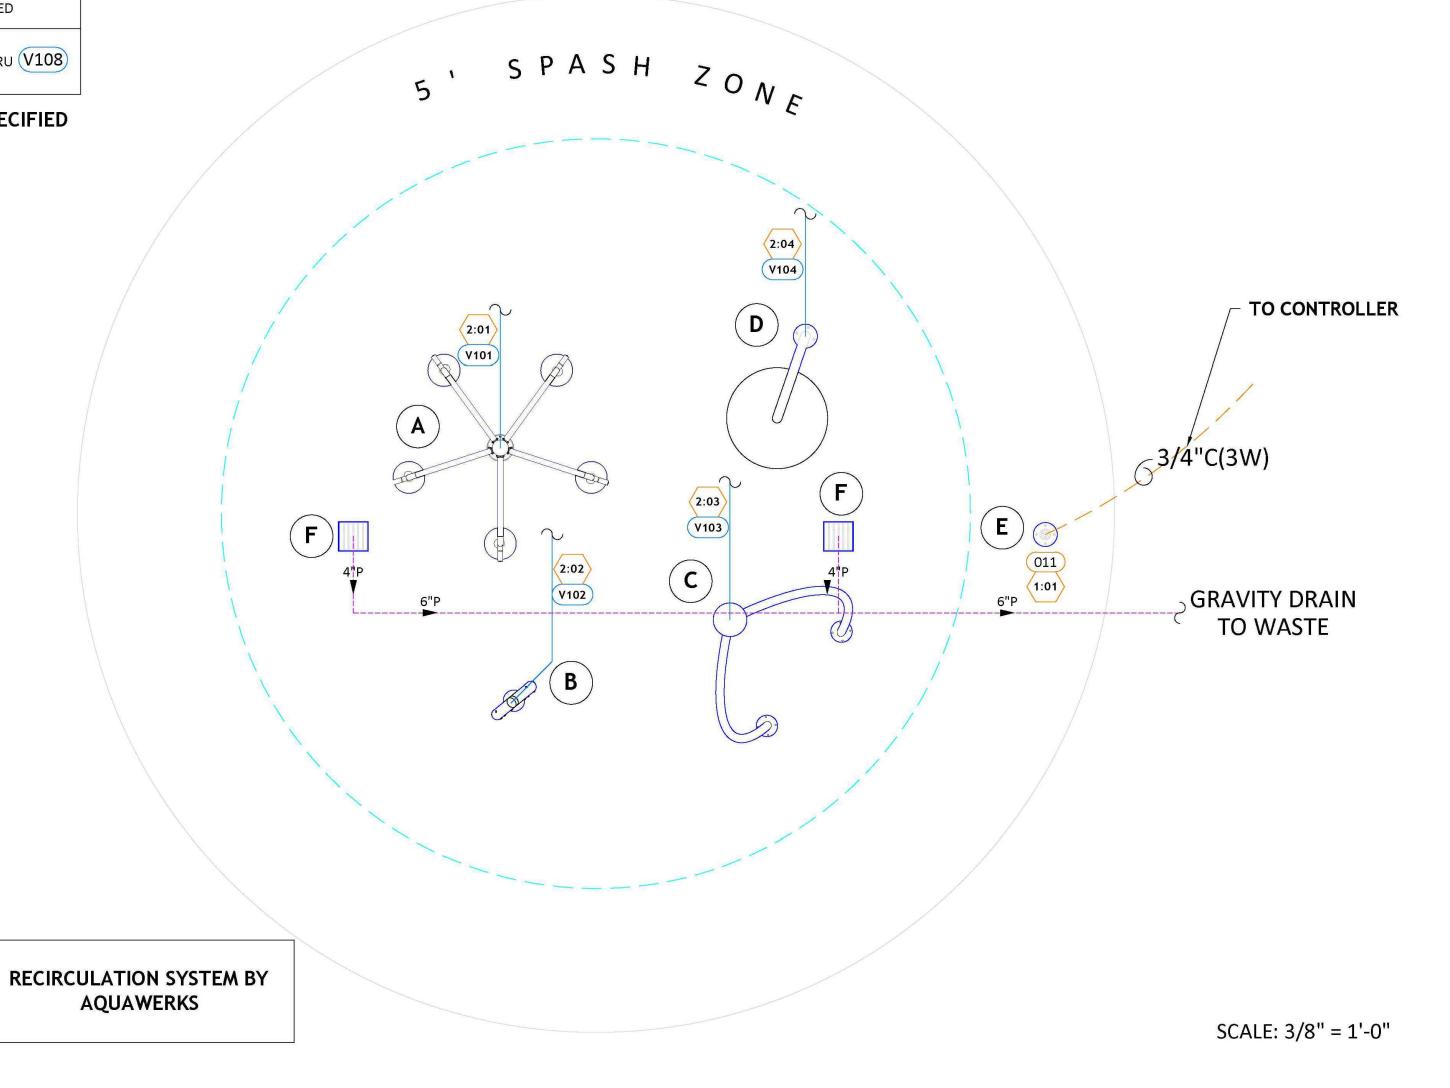

SPRAY GROUND / SPLASH PAD

w80474 Fe cos, Texas 78667-0 rodyssey.com

 ∞

804

SHEET

JND SALES

C:\Users\User\Dropbox\SHLA\Projects\2022\22-021-Shilling Ave Park\Tasks-CAD\ConDocs\22-021-LSBase.dwg



7

DATE /

74

W804

VER.

804

 \geq

SHEET

SPRAY GROUND / SPLASH PAD

SCALE: NTS

Prepared for: City of Lathrop

390 Towne Centre Drive Lathrop, CA 95330 (209) 941-7200

Project:

SHILLIN


Revision:

1 Addendum 1 5/25/23


Date: 04 May 2023 RSH RSH Checked: 22-021 Project No.: As shown

Sheet: Site Construction


Details

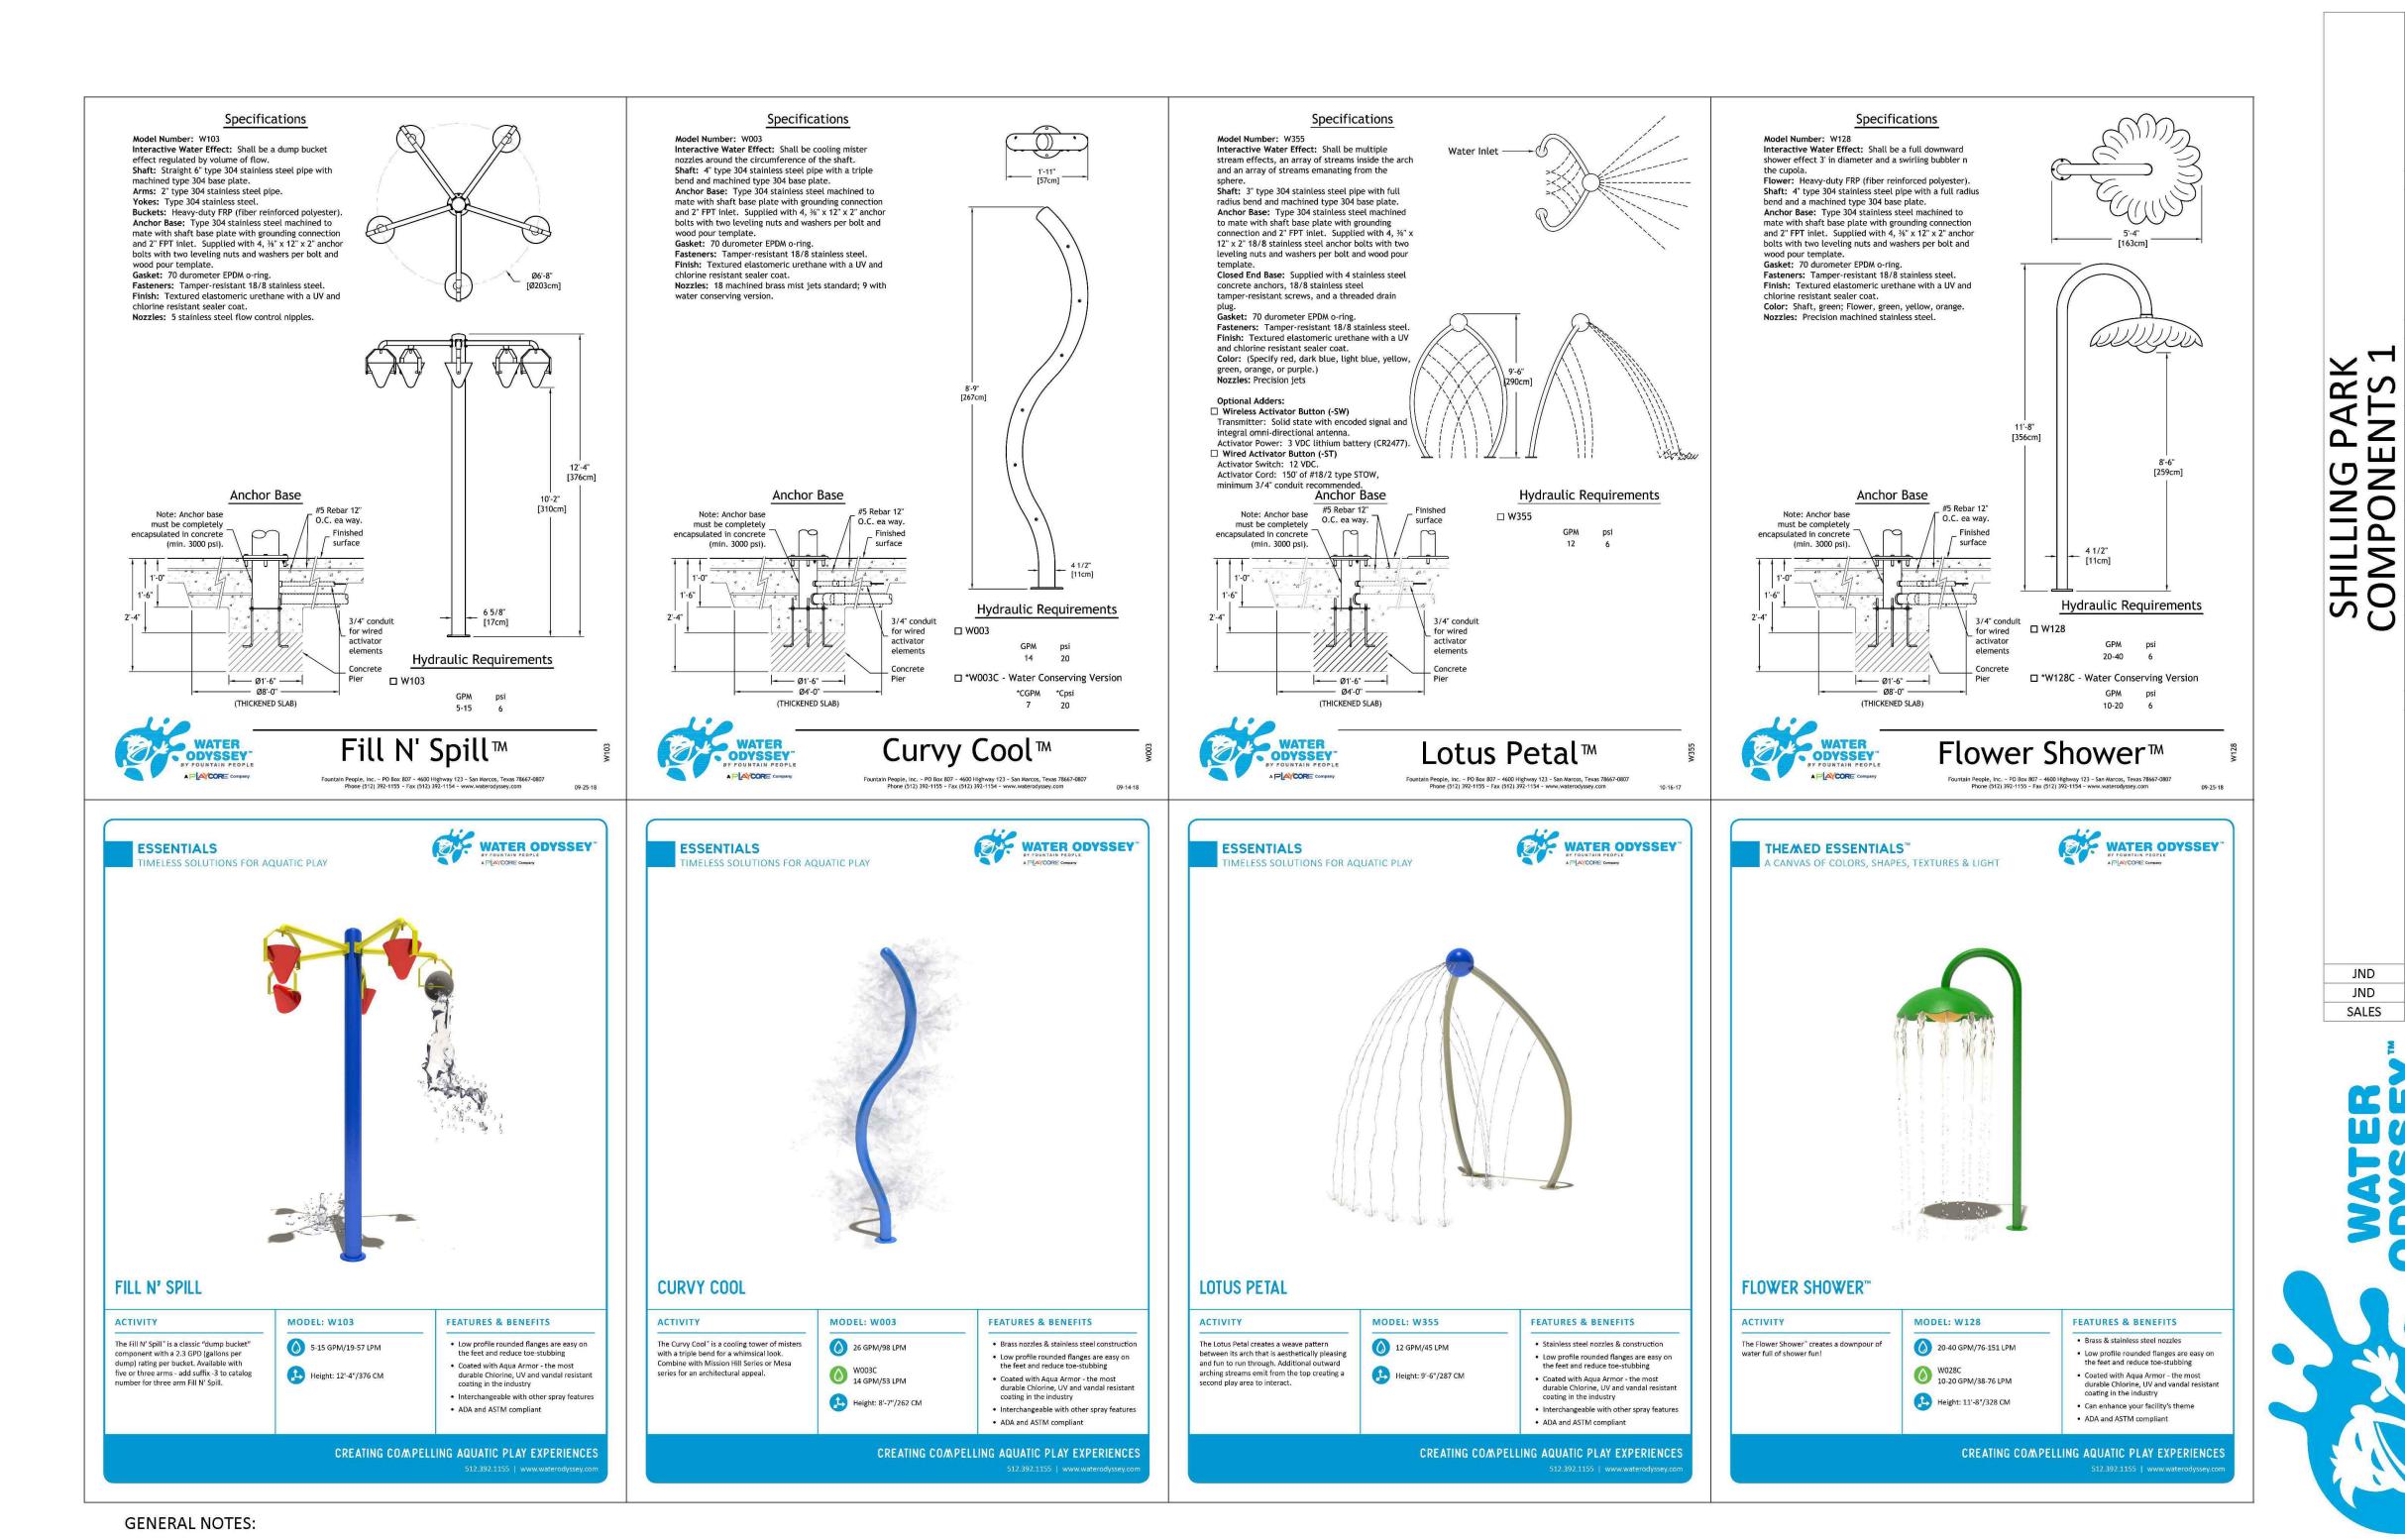

C:\Users\User\Dropbox\SHLA\Projects\2022\22-021-Shilling Ave Park\Tasks-CAD\ConDocs\22-021-LSBase.dwg

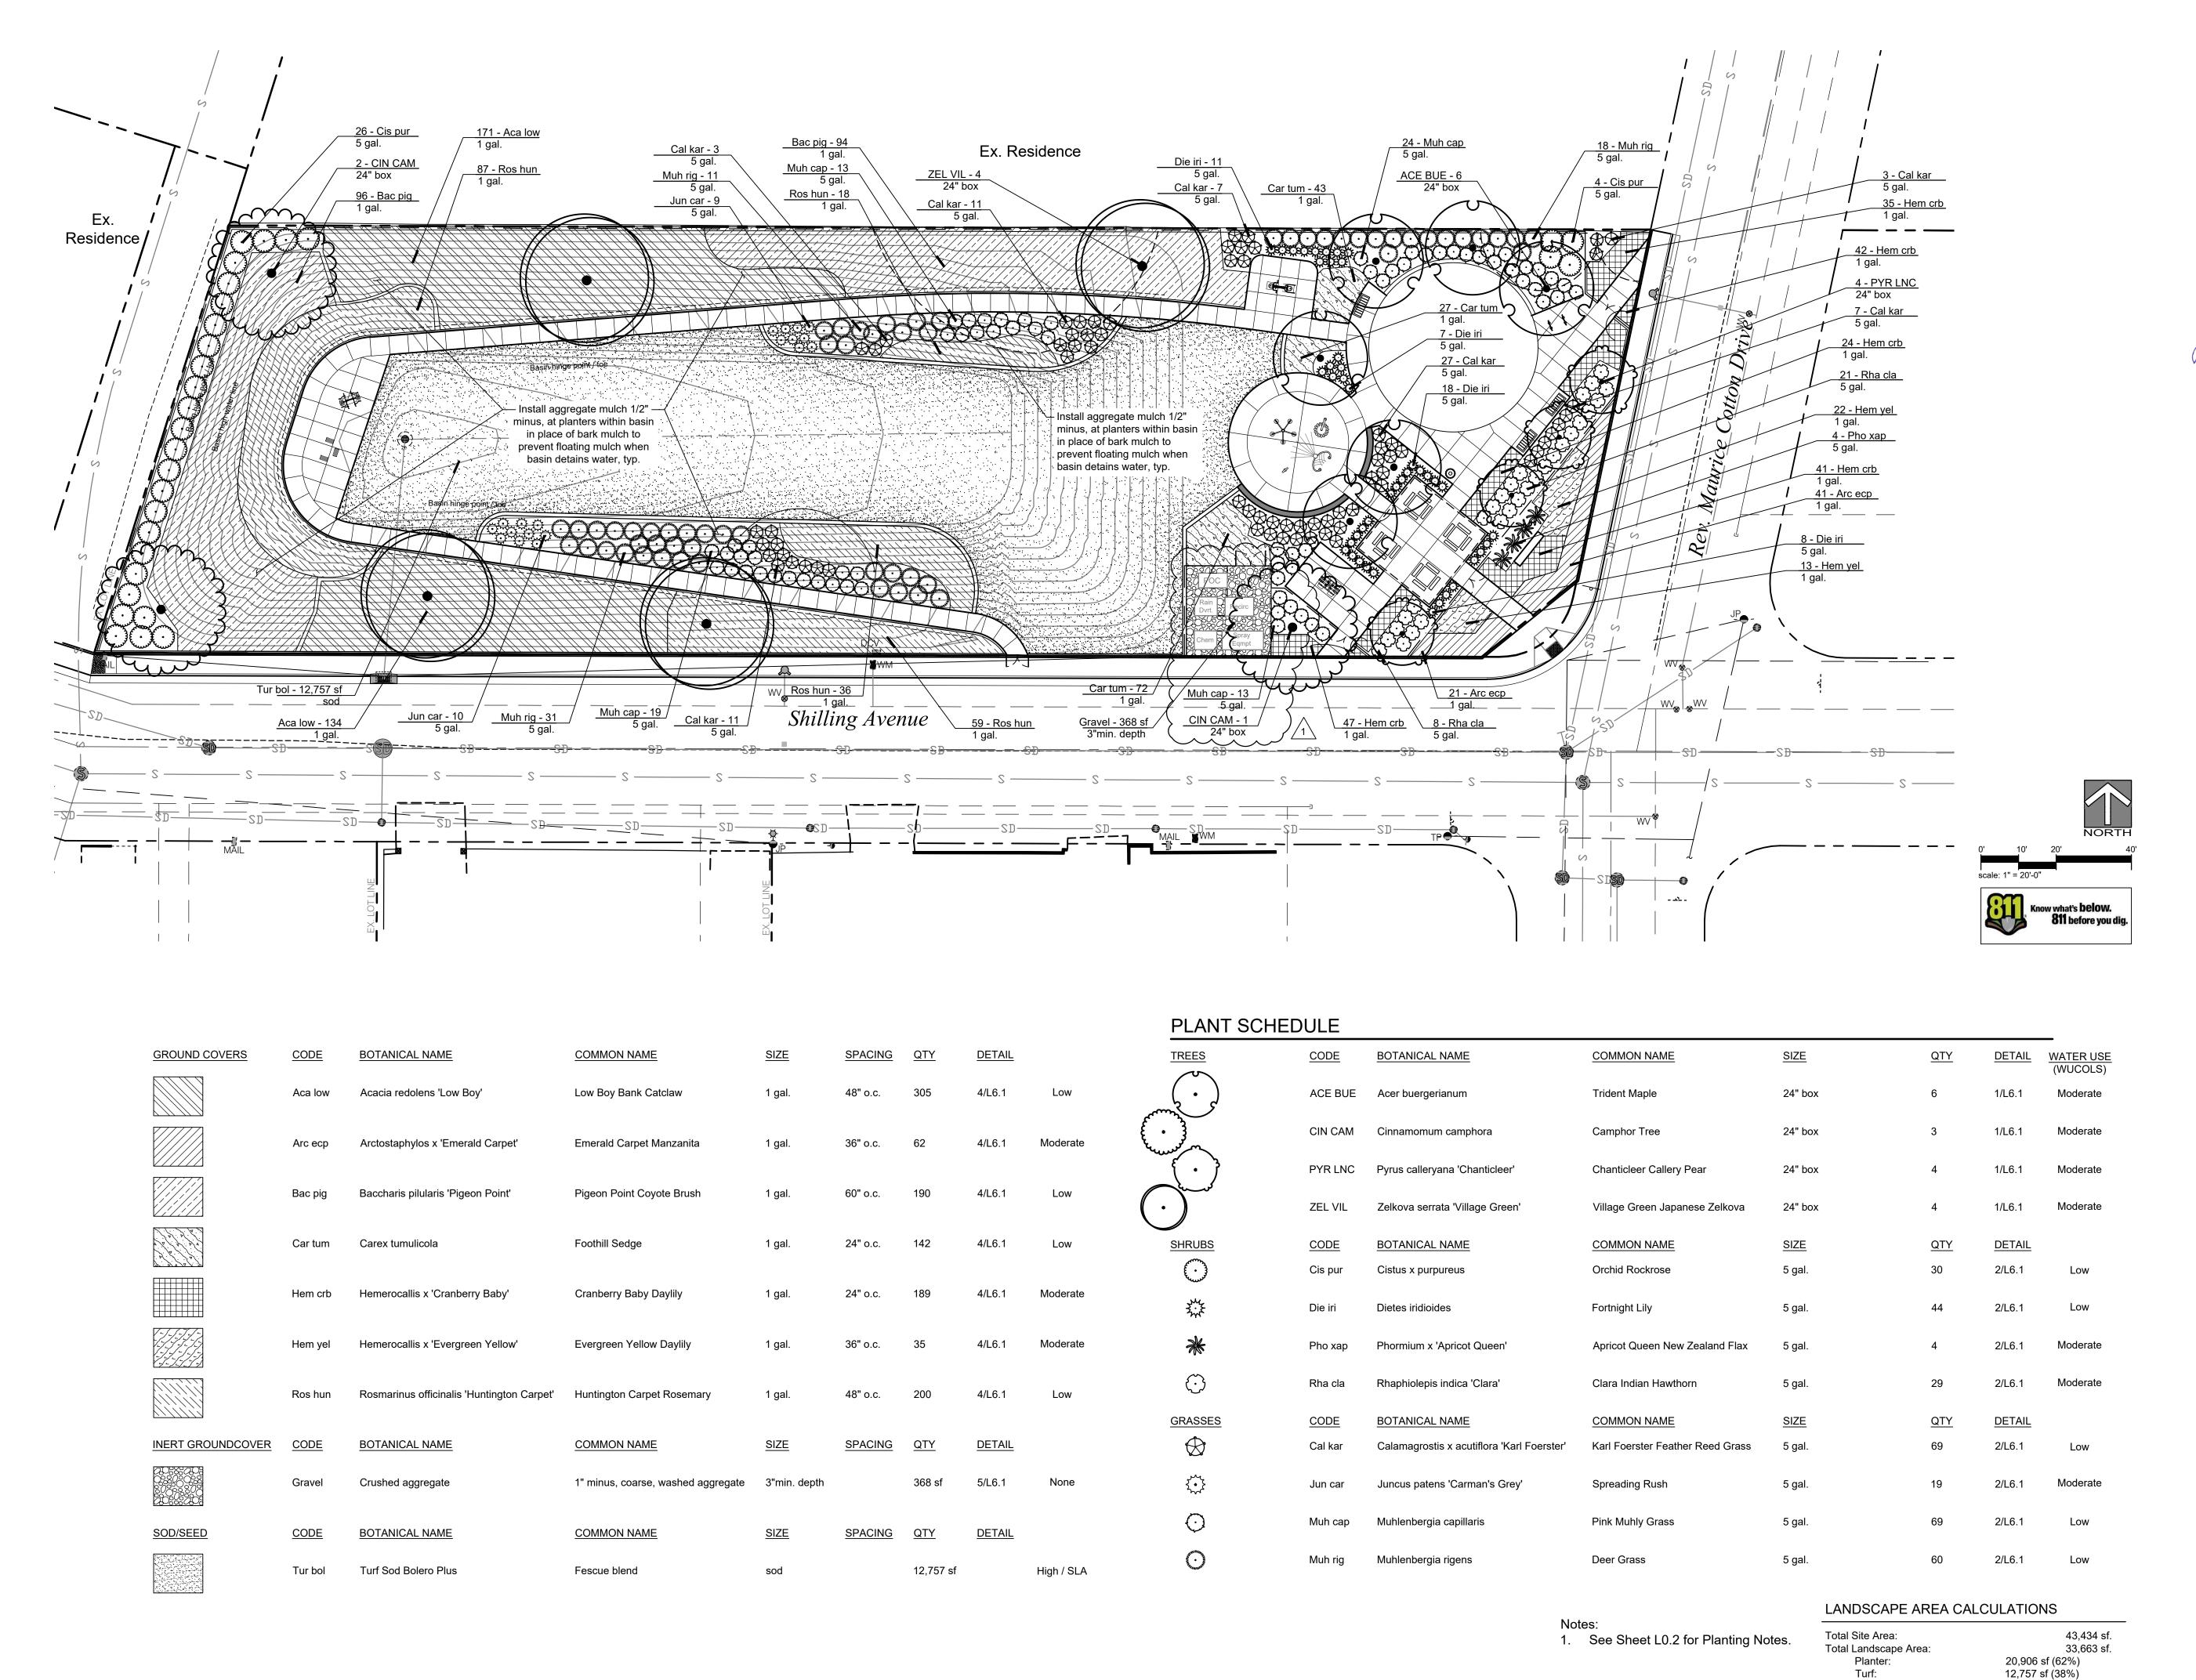



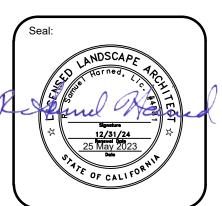

www.harnedla.com

Prepared for:

City of Lathrop
390 Towne Centre Drive
Lathrop, CA 95330
(209) 941-7200

Proje

SHILLING PARK

Revision:

1 Addendum 1 5/25/23

 Date:
 04 May 2023

 Drawn:
 RSH

 Checked:
 RSH

 Project No.:
 22-021

 Scale:
 1" = 20'-0"

Planting
Plan

L4.1